# PROPOSED



PLAT MAP 38, BLOCK 35 LOT 2
ZONING DISTRICTS: BL-1.0 and RL-7
BUSINESS LIMITED and
SINGLE FAMILY DISTRICT
1059 GRAFTON STREET
WORCESTER, MA
BOOK 69210, PAGE 201

# **ENGINEERS**




RI 02886 North Attleboro, MA 02763 1) 738-5660 Phone: (508) 695-1700 Email: cei@crossmaneng.com

JUNE 2023 SHEET 1 of 21

# OWNER/APPLICANT

1059 GRAFTON STREET, LLC C/O BASS, DOHERTY & FINKS, P.C. 1380 SOLDIERS FIELD ROAD BOSTON, MA 02135-1023

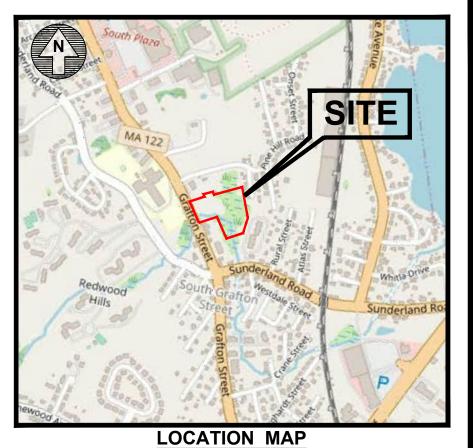

SCALE: 1"=1,000"

#### **INDEX OF DRAWINGS**

# RAWING No. PLAN C1 GENERAL NOTES and LEG

C1 GENERAL NOTES and LEGEND
C2 AERIAL MAP and CONSERVATION AREA
C3 RADIUS MAP
C4 EXISTING CONDITIONS PLAN
C5 SITE LAYOUT PLAN
C6 GRADING and DRAINAGE PLAN
C7 UTILITY PLAN
C8 SOIL EROSION and SEDIMENT CONTROL PLAN
C9 MISCELLANEOUS DETAILS PLAN No. 1
C10 MISCELLANEOUS DETAILS PLAN No. 2
C11 MISCELLANEOUS DETAILS PLAN No. 3

MISCELLANEOUS DETAILS PLAN No. 4
MISCELLANEOUS DETAILS PLAN No. 5
MISCELLANEOUS DETAILS PLAN No. 6
LIGHTING PLAN
LANDSCAPE PLAN
LANDSCAPE DETAIL PLAN
CONCEPTUAI FLOOR PLAN
BUILDING ELEVATIONS

REFERENCE

PERSPECTIVES

ALTA SURVEY

# REVISIONS

REVISION	DESCRIPTION	DATE
1	PLANNING BOARD COMMENTS	08/01/23
2	CITY COMMENTS	08/18/23
3	SEWER CONNECTION	01/25/24

ENGINEERING AND HAVE BEEN PREPARED FOR THEIR CLIENT FOR A SPECIFIC SITE AND PROJECT. THESE DRAWINGS ARE NOT TO BE COPIED OR USED FOR ANY OTHER PURPOSE WITHOUT THE WRITTEN CONSENT OF CROSSMAN ENGINEERING.

THESE DRAWINGS ARE THE PROPERTY OF CROSSMAN

#### **GENERAL NOTES**

- 1. ALL EXISTING UTILITIES HAVE BEEN PLOTTED BASED UPON BEST AVAILABLE INFORMATION AND REPRESENT APPROXIMATE LOCATIONS. THE CONTRACTOR SHALL VERIFY THE LOCATIONS OF ALL EXISTING DRAINAGE AND UTILITIES, BOTH UNDERGROUND AND OVERHEAD, BEFORE EXCAVATION BEGINS IN ACCORDANCE WITH "DIG SAFE PROGRAM LAW" ENACTED BY THE MASSACHUSETTS LEGISLATURE AND BY CONTACTING THE INDIVIDUAL UTILITY COMPANIES. EXCAVATION SHALL BE IN ACCORDANCE WITH ALL STATUTES, ORDINANCES, RULES AND REGULATIONS OF ANY MUNICIPALITY, STATE OR FEDERAL AGENCY THAT MAY APPLY. ANY DAMAGE TO EXISTING UTILITIES SHALL BE THE CONTRACTOR'S RESPONSIBILITY. A MINIMUM ADVANCE NOTICE OF 72 HOURS IS REQUIRED PRIOR TO START OF CONSTRUCTION.
- 2. IN ADDITION TO THE CONTRACT DOCUMENTS, SPECIFICATIONS TO GOVERN THIS PROJECT ARE MASSACHUSETTS STANDARD SPECIFICATIONS, FOR ALL EXCAVATION, PLACEMENT OF FILL, PIPE INSTALLATION. HOT MIX ASPHALT PAVEMENT, CONCRETE AND SAWCUTTING, THE CONTRACTOR SHALL PERFORM THE WORK IN FULL COMPLIANCE WITH THE COMMONWEALTH OF MASSACHUSETTS, HIGHWAY DEPARTMENT (DEPARTMENT OF TRANSPORTATION) STANDARD SPECIFICATIONS FOR HIGHWAYS AND BRIDGES, BOSTON MASSACHUSETTS, INCLUDING LATEST REVISIONS AND SUPPLEMENTAL SPECIFICATIONS...
- 3. THE CONTRACTOR MUST VERIFY PRIOR TO CONSTRUCTION THAT ALL REQUIRED AUTHORIZATION TO PERFORM WORK HAS BEEN OBTAINED. THE CONTRACTOR SHALL BE SOLELY RESPONSIBLE FOR CONSTRUCTION OPERATIONS INCLUDING ALL ACTIONS OR OMISSIONS OF ANY SUBCONTRACTORS, AGENTS OR EMPLOYEES. THE CONTRACTOR MUST ENSURE THAT THE CONDITIONS OF ALL PERMITS, SPECIFICATIONS AND FEDERAL, STATE AND LOCAL REGULATIONS ARE STRICTLY ENFORCED. THE CONTRACTOR IS ALSO RESPONSIBLE FOR ASPECTS OF ON-SITE SAFETY INCLUDING ANY DAMAGE TO EXISTING STRUCTURES.
- 4. WORK SHOWN ON THE PLANS FOR WHICH THERE ARE NO PARTICULAR DETAILS, SPECIFICATIONS OR PAYMENT ITEM DOES NOT RELIEVE THE CONTRACTOR FROM FURNISHING AND INSTALLING THE WORK. THE CONTRACTOR SHALL THOROUGHLY EXAMINE THE CONTRACT DOCUMENTS AND PLANS AND INSPECT THE SITE. AND THE BID PRICE SHALL INCLUDE ALL SERVICES AND MATERIALS NECESSARY TO COMPLETE THE PROJECT. ANY CHANGES TO THE PROJECT OR THE INSTALLATION OF AN ITEM FOR WHICH NO PARTICULAR DETAIL OR SPECIFICATION WAS PROVIDED MUST BE REVIEWED BY AND MUST BE ACCEPTABLE TO THE
- 5. CONTRACTOR IS RESPONSIBLE TO VERIFY ALL EXISTING CONDITIONS AND DIMENSIONS PRIOR TO CONSTRUCTION. THE CONTRACTOR SHALL NOTIFY THE ENGINEER OF ANY DISCREPANCIES PRIOR TO ANY
- 6. ALL DISTURBED AREAS SHALL BE REPLACED IN KIND UNLESS OTHERWISE SHOWN OR OTHERWISE INSTRUCTED IN WRITING BY THE OWNER.
- 7. CONTRACTOR SHALL EXCAVATE TEST PITS TO CONFIRM UTILITY LOCATIONS/ELEVATIONS AT POTENTIAL CONFLICT POINTS (UTILITY/DRAIN CROSSINGS).
- 8. THE CONTRACTOR SHALL USE CARE WHEN WORKING NEAR UTILITY POLES AND WIRING SO AS TO NOT DISTURB ELECTRICAL/TELEPHONE/CABLE SERVICE TO THE CUSTOMERS. IT IS THE CONTRACTORS RESPONSIBILITY TO MAINTAIN THESE SERVICES AT ALL TIMES.
- 9. THE CONTRACTOR SHALL, AT NO ADDITIONAL EXPENSE, BRACE UTILITY POLES IF REQUIRED, AND REPAIR ANY DAMAGE TO EXISTING UTILITIES, SIDEWALKS, GUARDRAILS, CURBS, PAVING, SHRUBS, TREES, STONE WALLS, LAWNS, ETC.
- 10. CHANGE ORDERS MAY ONLY BE APPROVED FOR PAYMENT BY THE OWNER.
- 11. ALL OPEN EXCAVATIONS SHALL BE ADEQUATELY SAFEGUARDED BY PROVIDING TEMPORARY BARRICADES, CAUTION SIGNS, LIGHTS AND OTHER MEANS TO PREVENT ACCIDENTS TO PERSONS AND DAMAGE TO PROPERTY. THE CONTRACTOR SHALL AT NO ADDITIONAL EXPENSE TO THE OWNER, PROVIDE SUITABLE AND SAFE CONDITIONS AT ALL AREAS OF THE WORK SITE AND SHALL PROVIDE SAFE VEHICULAR AND PEDESTRIAN ACCESS AROUND ALL WORK AREAS.
- 12. WATER GENERATED AS A RESULT OF TRENCH DEWATERING SHALL BE DISCHARGED TO EXISTING DRAINAGE STRUCTURES. CONTRACTOR SHALL PROVIDE, AT NO ADDITIONAL EXPENSE, ADEQUATE EROSION CONTROL, FRAC TANKS OR SEDIMENTATION CONTROLS SUBJECT TO THE APPROVAL OF THE CONSERVATION COMMISSION.
- 13. ALL WORK SHALL BE PERFORMED IN ACCORDANCE WITH THE REQUIREMENTS AND STANDARD SPECIFICATIONS OF THE CITY OR WORCESTER DEPARTMENT OF PUBLIC WORKS. ALL EXCAVATION, BACKFILL AND RESTORATION WORK SHALL MEET THE TOWN'S SPECIFICATIONS.
- 14. THE LAYOUT SHOWN REPRESENTS A GRAPHICAL DESIGN, ALL EXISTING UTILITY LOCATIONS AND FLEVATIONS. ARE TO BE CONFIRMED BY THE CONTRACTOR PRIOR TO CONSTRUCTION. ANY ITEM FOUND WHICH DOES NOT MATCH THE PLANS MUST BE BROUGHT TO THE ENGINEER'S ATTENTION PRIOR TO CONSTRUCTION FOR REVIEW. NO WORK SHALL PROCEED UNTIL AUTHORIZED BY THE ENGINEER.
- 15. THE CONTRACTOR SHALL NOTIFY THE ENGINEER PRIOR TO REMOVAL AND/OR INSTALLATION OF UTILITIES ON SITE. THE COORDINATION IS NECESSARY FOR THE ENGINEER TO SCHEDULE SITE INSPECTIONS. INSTALLATIONS PERFORMED WITHOUT INSPECTIONS BY THE ENGINEER MAY WARRANT COMPLETE REMOVAL AND REINSTALLATION AT THE CONTRACTOR'S SOLE EXPENSE.
- 16. THE CONTRACTOR IS REQUIRED TO MAINTAIN DETAILED AS-BUILT INFORMATION FOR ALL UTILITY INSTALLATIONS. AS-BUILT INFORMATION MUST INCLUDE MATERIAL LIST. PIPE DEPTH AND SWING TIE LOCATIONS (2 MINIMUM) FROM NEW PIPE TO BUILDING CORNERS. ALL PIPE BEND/ELBOW LOCATIONS SHALL BE DIMENSIONED. FINAL PAYMENT WILL NOT BE MADE UNTIL SUITABLE AS—BUILT DATA IS
- 17. AS-BUILT AUTOCAD FILES AND HARD COPY PLANS SHALL BE PROVIDED UPON COMPLETION OF WORK. CONTRACTOR IS RESPONSIBLE FOR THIS INFORMATION. FINAL PAYMENT TO CONTRACTOR SHALL NOT BE PROVIDED UNTIL ACCEPTABLE AUTOCAD FILES OF THE AS-BUILTS ARE SUBMITTED AND APPROVED BY THE

#### STANDARD NOTES

- 1. ANY DAMAGE TO EXISTING PAVEMENT, BRIDGES, CULVERTS, CONDUIT, SIDEWALK, FENCES, ETC., CAUSED BY THE CONTRACTOR SHALL BE REPAIRED BY THE CONTRACTOR AT NO ADDITIONAL COST TO THE OWNER.
- 2. THE CONTRACTOR SHALL PLACE ALL EQUIPMENT AND MATERIAL AS FAR AWAY AS POSSIBLE FROM THE EDGE OF THE TRAVEL LANE SO AS NOT TO CAUSE A SAFETY HAZARD.
- 3. IT IS THE CONTRACTOR'S RESPONSIBILITY TO ENSURE THAT THE EXISTING CONDITIONS ARE NOT OBLITERATED BEFORE CONTROL POINTS ARE LOCATED AND CONSTRUCTION LAYOUT IS ESTABLISHED. THE CONSTRUCTION LAYOUT SHALL BE PROVIDED BY THE CONTRACTOR.
- 4. ASPHALT EMULSION TACK COAT SHALL BE PLACED PRIOR TO PAVEMENT PLACEMENT ON ANY NEW COURSE WHICH HAS BEEN OPEN TO TRAFFIC. OR ANY NEW COURSE WHICH HAS BEEN EXPOSED FOR MORE THAN 3 DAYS, AND/OR AS DIRECTED BY THE ENGINEER. IT SHALL ALSO BE APPLIED TO VERTICAL PAVEMENT FACES BETWEEN ADJOINING PAVEMENT SECTIONS.
- 5. THE LIMITS OF CLEARING AND SURFACE DISTURBANCE MUST BE STRICTLY ADHERED TO IN ALL AREAS. IN ADDITION TO THOSE AREAS SPECIFICALLY DESIGNATED ON THE PLANS, THE CONTRACTOR WILL BE RESPONSIBLE FOR PROVIDING AND PLACING, AT HIS OWN EXPENSE, LOAM AND SEED IN AREAS WHICH ARE OUTSIDE OF THE PROJECT'S AREAS OF DISTURBANCE AND WHICH ARE IMPACTED BY CONSTRUCTION OPERATIONS INCLUDING THOSE AREAS WHERE VEHICLES, EQUIPMENT AND MATERIALS ARE STORED WITH THE PERMISSION OF THE ENGINEER.
- 6. CLEANING AND SWEEPING OF PAVEMENT WILL INCLUDE REMOVAL OF ALL PAVEMENT DEBRIS PRIOR TO THE PLACEMENT OF EACH BITUMINOUS PAVEMENT LIFT. ALL CLEANING AND SWEEPING SHALL BE DONE TO THE SATISFACTION OF THE ENGINEER.
- 7. THE CONTRACTOR SHALL BE RESPONSIBLE FOR MAINTAINING ALL ROADWAYS FREE OF DEBRIS RESULTING FROM THEIR CONSTRUCTION OPERATIONS. ALL DEBRIS SHALL BE REMOVED TO THE SATISFACTION OF THE ENGINEER AT NO ADDITIONAL COST TO THE OWNER.
- 8. NO FUEL STORAGE, VEHICLE REFUELING, OR EQUIPMENT STORAGE SHALL TAKE PLACE IN DESIGNATED WETLANDS. NOR WITHIN 100' OF ANY WATER BODY. THIS REQUIREMENT SHALL NOT SUPERSEDE ANY FEDERAL, STATE OR LOCAL LAW, ORDINANCE, RULE OR REGULATION THAT APPLIES TO THE SAME, UNLESS THIS REQUIREMENT IS MORE STRINGENT THAN SAID LAW, ORDINANCE, RULE OR REGULATION.
- 9. THE CONTRACTOR SHALL BE RESPONSIBLE TO ENSURE THAT AT THE END OF FINAL PAVING OPERATIONS. FLOW TO EXISTING DRAINAGE STRUCTURES HAS BEEN REESTABLISHED AND THAT NO ISOLATED DEPRESSIONS REMAIN. THERE SHALL BE NO SEPARATE PAYMENT FOR THIS PROVISION: IT SHALL BE CONSIDERED INCIDENTAL TO PAVING OPERATIONS.
- 10. ALL EMBANKMENTS AND TRENCH BACKFILL SHALL BE PLACED IN HORIZONTAL LAYERS NOT EXCEEDING 12" (AFTER COMPACTION) AND SHALL BE COMPACTED AS SPECIFIED BEFORE THE NEXT LAYER IS PLACED.

#### **FLOOD ZONE NOTE**


THE PROPOSED WORK AREA IS LOCATED WITHIN FLOOD ZONE X, AREAS DETERMINED TO BE OUTSIDE THE 0.2% ANNUAL CHANCE FLOOD. FLOOD ZONE INFORMATION IS SHOWN ON THE FLOOD INSURANCE RATE MAP FOR WORCESTER COUNTRY, MASSACHUSETTS (ALL JURISDICTIONS), PANEL 807 OF 1075, MAP NUMBER 25027C0807E, EFFECTIVE DATE: JULY 4, 2011.

#### PROPOSED PAVEMENT STRUCTURE


1-1/2" HOT MIX ASPHALT SURFACE COARSE 2-1/2" HOT MIX ASPHALT BINDER COURSE 12" GRAVEL BORROW SUBBASE

#### **UTILITY NOTES**

- 1. PRIOR TO ANY UTILITY CONSTRUCTION, THE CONTRACTOR MUST PERFORM ADDITIONAL TESTS TO:
  - A. CONFIRM THE EXISTING DEPTHS OF UTILITIES AT ALL PROPOSED CONNECTION POINTS AND POTENTIAL CROSSOVER (CONFLICT) POINTS.
  - B. CONFIRM THE EXTENT OF LEDGE WHICH MAY EXIST IN ALL ANTICIPATED UTILITY TRENCH AREAS. PRIOR TO CONSTRUCTION. THE FINDINGS ARE TO BE REVIEWED BY THE OWNER AND THE ENGINEER. IF NECESSARY, ALTERNATIVES TO MINIMIZE LEDGE REMOVAL AND UTILITY CONFLICTS WILL BE DEVELOPED. NO CONSTRUCTION WILL BE ALLOWED WITHOUT THE OWNER'S AUTHORIZATION.
  - C .THE CONTRACTOR SHALL DIG TEST HOLES TO VERIFY THE ELEVATIONS AND PIPE MATERIAL OF THE EXISTING WATER, GAS AND SANITARY SERVICES AT THE PROPOSED TIE-IN LOCATION.
- 2. ANY MODIFICATIONS TO THE PROPOSED UTILITIES TO AVOID CONFLICTS MUST BE APPROVED BY THE ENGINEER PRIOR TO CONSTRUCTION. NO EXTRA PAYMENT TO THE CONTRACTOR DUE TO RELOCATIONS WILL BE AUTHORIZED.
- 3. CONTRACTOR SHALL NOTIFY ALL UTILITY COMPANIES PRIOR TO TIE-IN.
- 4. THIS UTILITY PLAN DOES NOT REPRESENT THE SITE ELECTRICAL/TELEPHONE/COMMUNICATION SYSTEM DESIGNS AND DOES NOT REPRESENT IRRIGATION PIPING. CONTRACTOR SHALL COORDINATE WITH OWNER TO VERIFY IRRIGATION PIPING REQUIREMENTS.
- 5. THE CONTRACTOR MUST LOCATE THE EXISTING WATER MAIN TO OBTAIN THE PROPER OUTSIDE DIAMETER TO SIZE THE SLEEVE.
- 6. THE CONTRACTOR IS RESPONSIBLE TO ENSURE THAT ALL UTILITY PIPE SIZES INCLUDING WATER, SEWER AND GAS ARE VERIFIED BY THE ARCHITECT PRIOR TO ORDERING PIPE OR RELATED MATERIAL.
- 7. ALL PROPOSED PIPES AND CONDUITS SHALL BE INSTALLED TO MEET H-20 LOADING CAPACITY. ALL MATERIAL AND TRENCHING METHODS SHALL CONFORM TO H-20 LOADING CAPACITIES. CONTRACTOR SHALL SUBMIT SHOP DRAWINGS/CATALOG CUTS FOR PROPOSED PIPE AND CONDUIT TO ENGINEER FOR APPROVAL.

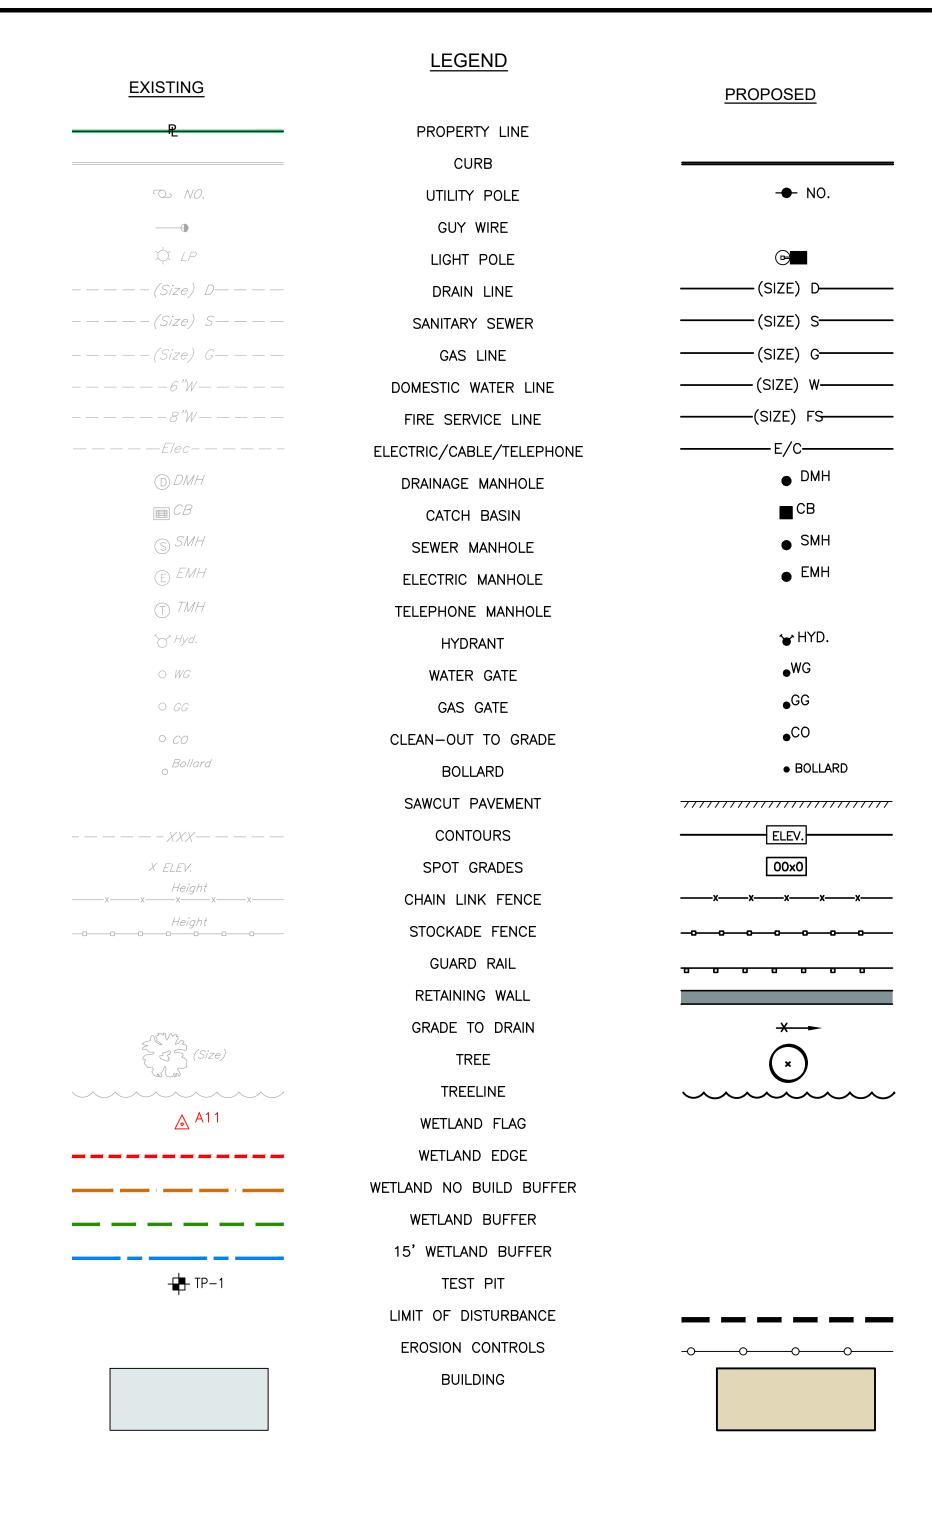

### SOIL EVALUATION DATA SOIL EVALUATIONS WERE CONDUCTED BY CROSSMAN ENGINEERING ON APRIL 27, 2023.

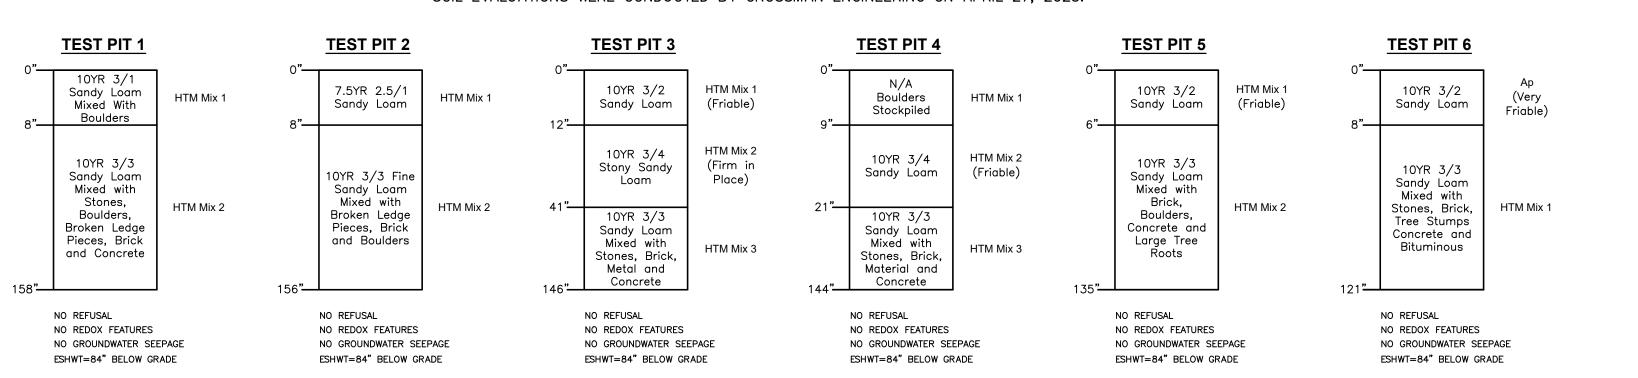



 Environmental Site Planning Surveying Permitting

#### Crossman Engineering

151 Centerville Road 103 Commonwealth Avenue Warwick, RI 02886 North Attleboro, MA 02763 Phone (401) 738-5660 Phone (508) 695-1700

Email: cei@crossmaneng.com

THESE DRAWINGS ARE THE PROPERTY OF CROSSMAN ENGINEERING AND HAVE BEEN PREPARED FOR THEIR CLIEN FOR A SPECIFIC SITE AND PROJECT. THESE DRAWINGS ARI NOT TO BE COPIED OR USED FOR ANY OTHER PURPOSE WITHOUT THE WRITTEN CONSENT OF CROSSMAN ENGINEERIN

KEY PLAN

PROJECT TITLE:

PROPOSED CAR WASH PLAT MAP 38, **BLOCK 35 LOT 2** ZONING DISTRICTS: BL-1.0 and RL-7 **BUSINESS LIMITED and** SINGLE FAMILY DISTRICT **1059 GRAFTON STREET** 

**WORCESTER, MA** 

PREPARED FOR:

1059 GRAFTON STREET, LLC C/O BASS. DOHERTY & FINKS. P.C. 1380 SOLDIERS FIELD ROAD **BOSTON, MA 02135-1023** 

DRAWING TITLE:

# **GENERAL NOTES** and LEGEND

JUNE 2023 NO SCALE DWG. NAME: M280-C01-NOTE-R3.dwg REVISIONS

NUMBER

REMARKS DATEPLANNING BOARD COMMENTS 08/01/2 CITY COMMENTS 08/18/23 SEWER CONNECTION 01/25/24

DRAWING NUMBER

SHEET: 2 OF: 21





# Crossman Engineering

Rhode Island
151 Centerville Road
Warwick, RI 02886
Massachusetts
103 Commonwealth Avenue
North Attleboro, MA 02763 Phone (401) 738-5660 Phone (508) 695-1700

Site Planning

Email: cei@crossmaneng.com

THESE DRAWINGS ARE THE PROPERTY OF CROSSMAN ENGINEERING AND HAVE BEEN PREPARED FOR THEIR CLIENT FOR A SPECIFIC SITE AND PROJECT. THESE DRAWINGS ARE NOT TO BE COPIED OR USED FOR ANY OTHER PURPOSE WITHOUT THE WRITTEN CONSENT OF CROSSMAN ENGINEERING.

KEY PLAN

PROJECT TITLE:

# **PROPOSED CAR WASH** PLAT MAP 38,

BLOCK 35 LOT 2 ZONING DISTRICTS: BL-1.0 and RL-7 **BUSINESS LIMITED and** SINGLE FAMILY DISTRICT 1059 GRAFTON STREET WORCESTER, MA

PREPARED FOR:

1059 GRAFTON STREET, LLC C/O BASS, DOHERTY & FINKS, P.C. 1380 SOLDIERS FIELD ROAD BOSTON, MA 02135-1023

DRAWING TITLE:

JUNE 2023

# **AERIAL MAP** and **CONSERVATION AREA**


1"=40'


M280-C02-AERIAL-R3.dwg REVISIONS

NUMBER	REMARKS	DATE
1	PLANNING BOARD COMMENTS	08/01/23
2	CITY COMMENTS	08/18/23
3	SESMEWRERCON MIERETISON	01/25/24

DRAWING NUMBER

SHEET: 3 OF: 21

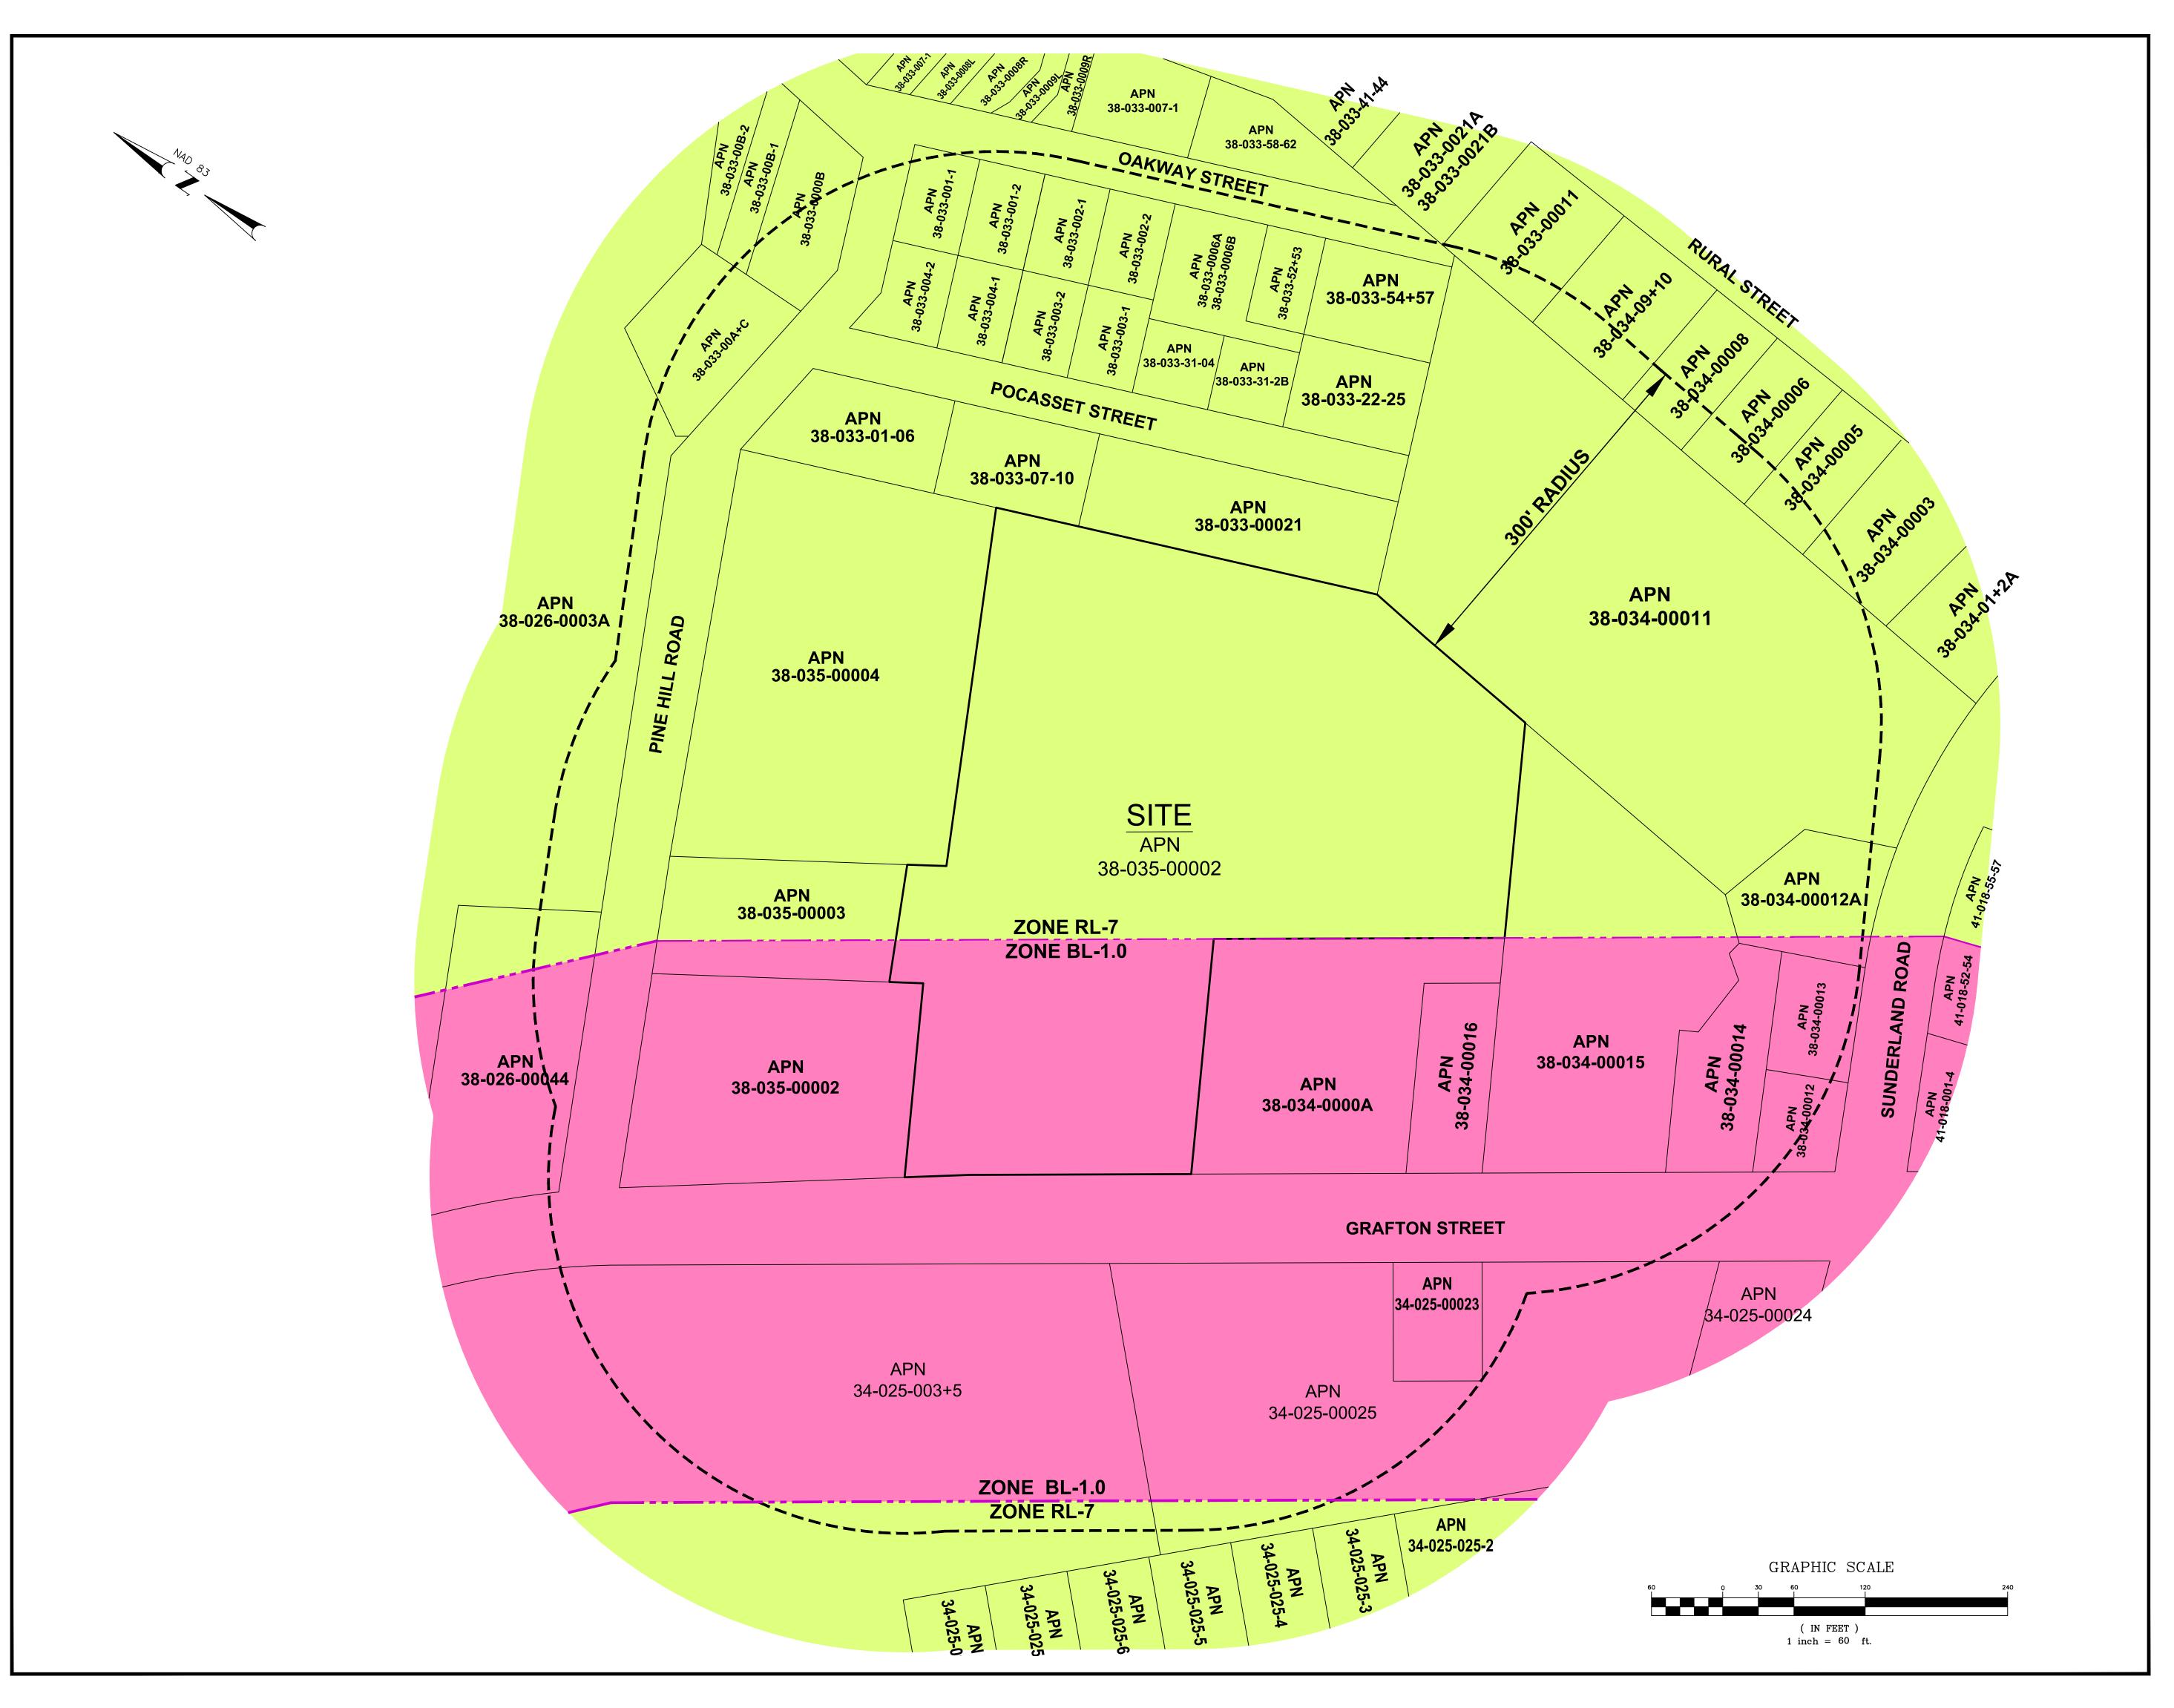

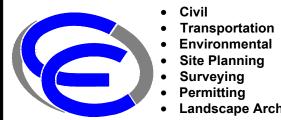

 Landscape Architecture **Crossman Engineering** 

Rhode Island
151 Centerville Road
Warwick, RI 02886

Massachusetts
103 Commonwealth Avenue
North Attleboro, MA 02763 Phone (401) 738-5660 Phone (508) 695-1700

 Environmental Site Planning SurveyingPermitting

Email: cei@crossmaneng.com

THESE DRAWINGS ARE THE PROPERTY OF CROSSMAN ENGINEERING AND HAVE BEEN PREPARED FOR THEIR CLIENT FOR A SPECIFIC SITE AND PROJECT. THESE DRAWINGS ARE NOT TO BE COPIED OR USED FOR ANY OTHER PURPOSE WITHOUT THE WRITTEN CONSENT OF CROSSMAN ENGINEERING.

KEY PLAN

PROJECT TITLE:

PROPOSED CAR WASH PLAT MAP 38, BLOCK 35 LOT 2 ZONING DISTRICTS: BL-1.0 and RL-7 **BUSINESS LIMITED and** 

SINGLE FAMILY DISTRICT 1059 GRAFTON STREET WORCESTER, MA

PREPARED FOR:

**1059 GRAFTON STREET, LLC** C/O BASS, DOHERTY & FINKS, P.C. 1380 SOLDIERS FIELD ROAD **BOSTON, MA 02135-1023** 

DRAWING TITLE:

## **RADIUS MAP**


1"=60' JUNE 2023 DWG. NAME:

M280-C03-RADIUS-R3.dwg REVISIONS

NUMBER	REMARKS	DATE
1	PLANNING BOARD COMMENTS	08/01/23
2	CITY COMMENTS	08/18/23
3	SEWER CONNECTION	01/25/24

DRAWING NUMBER

SHEET: 5 OF: 21

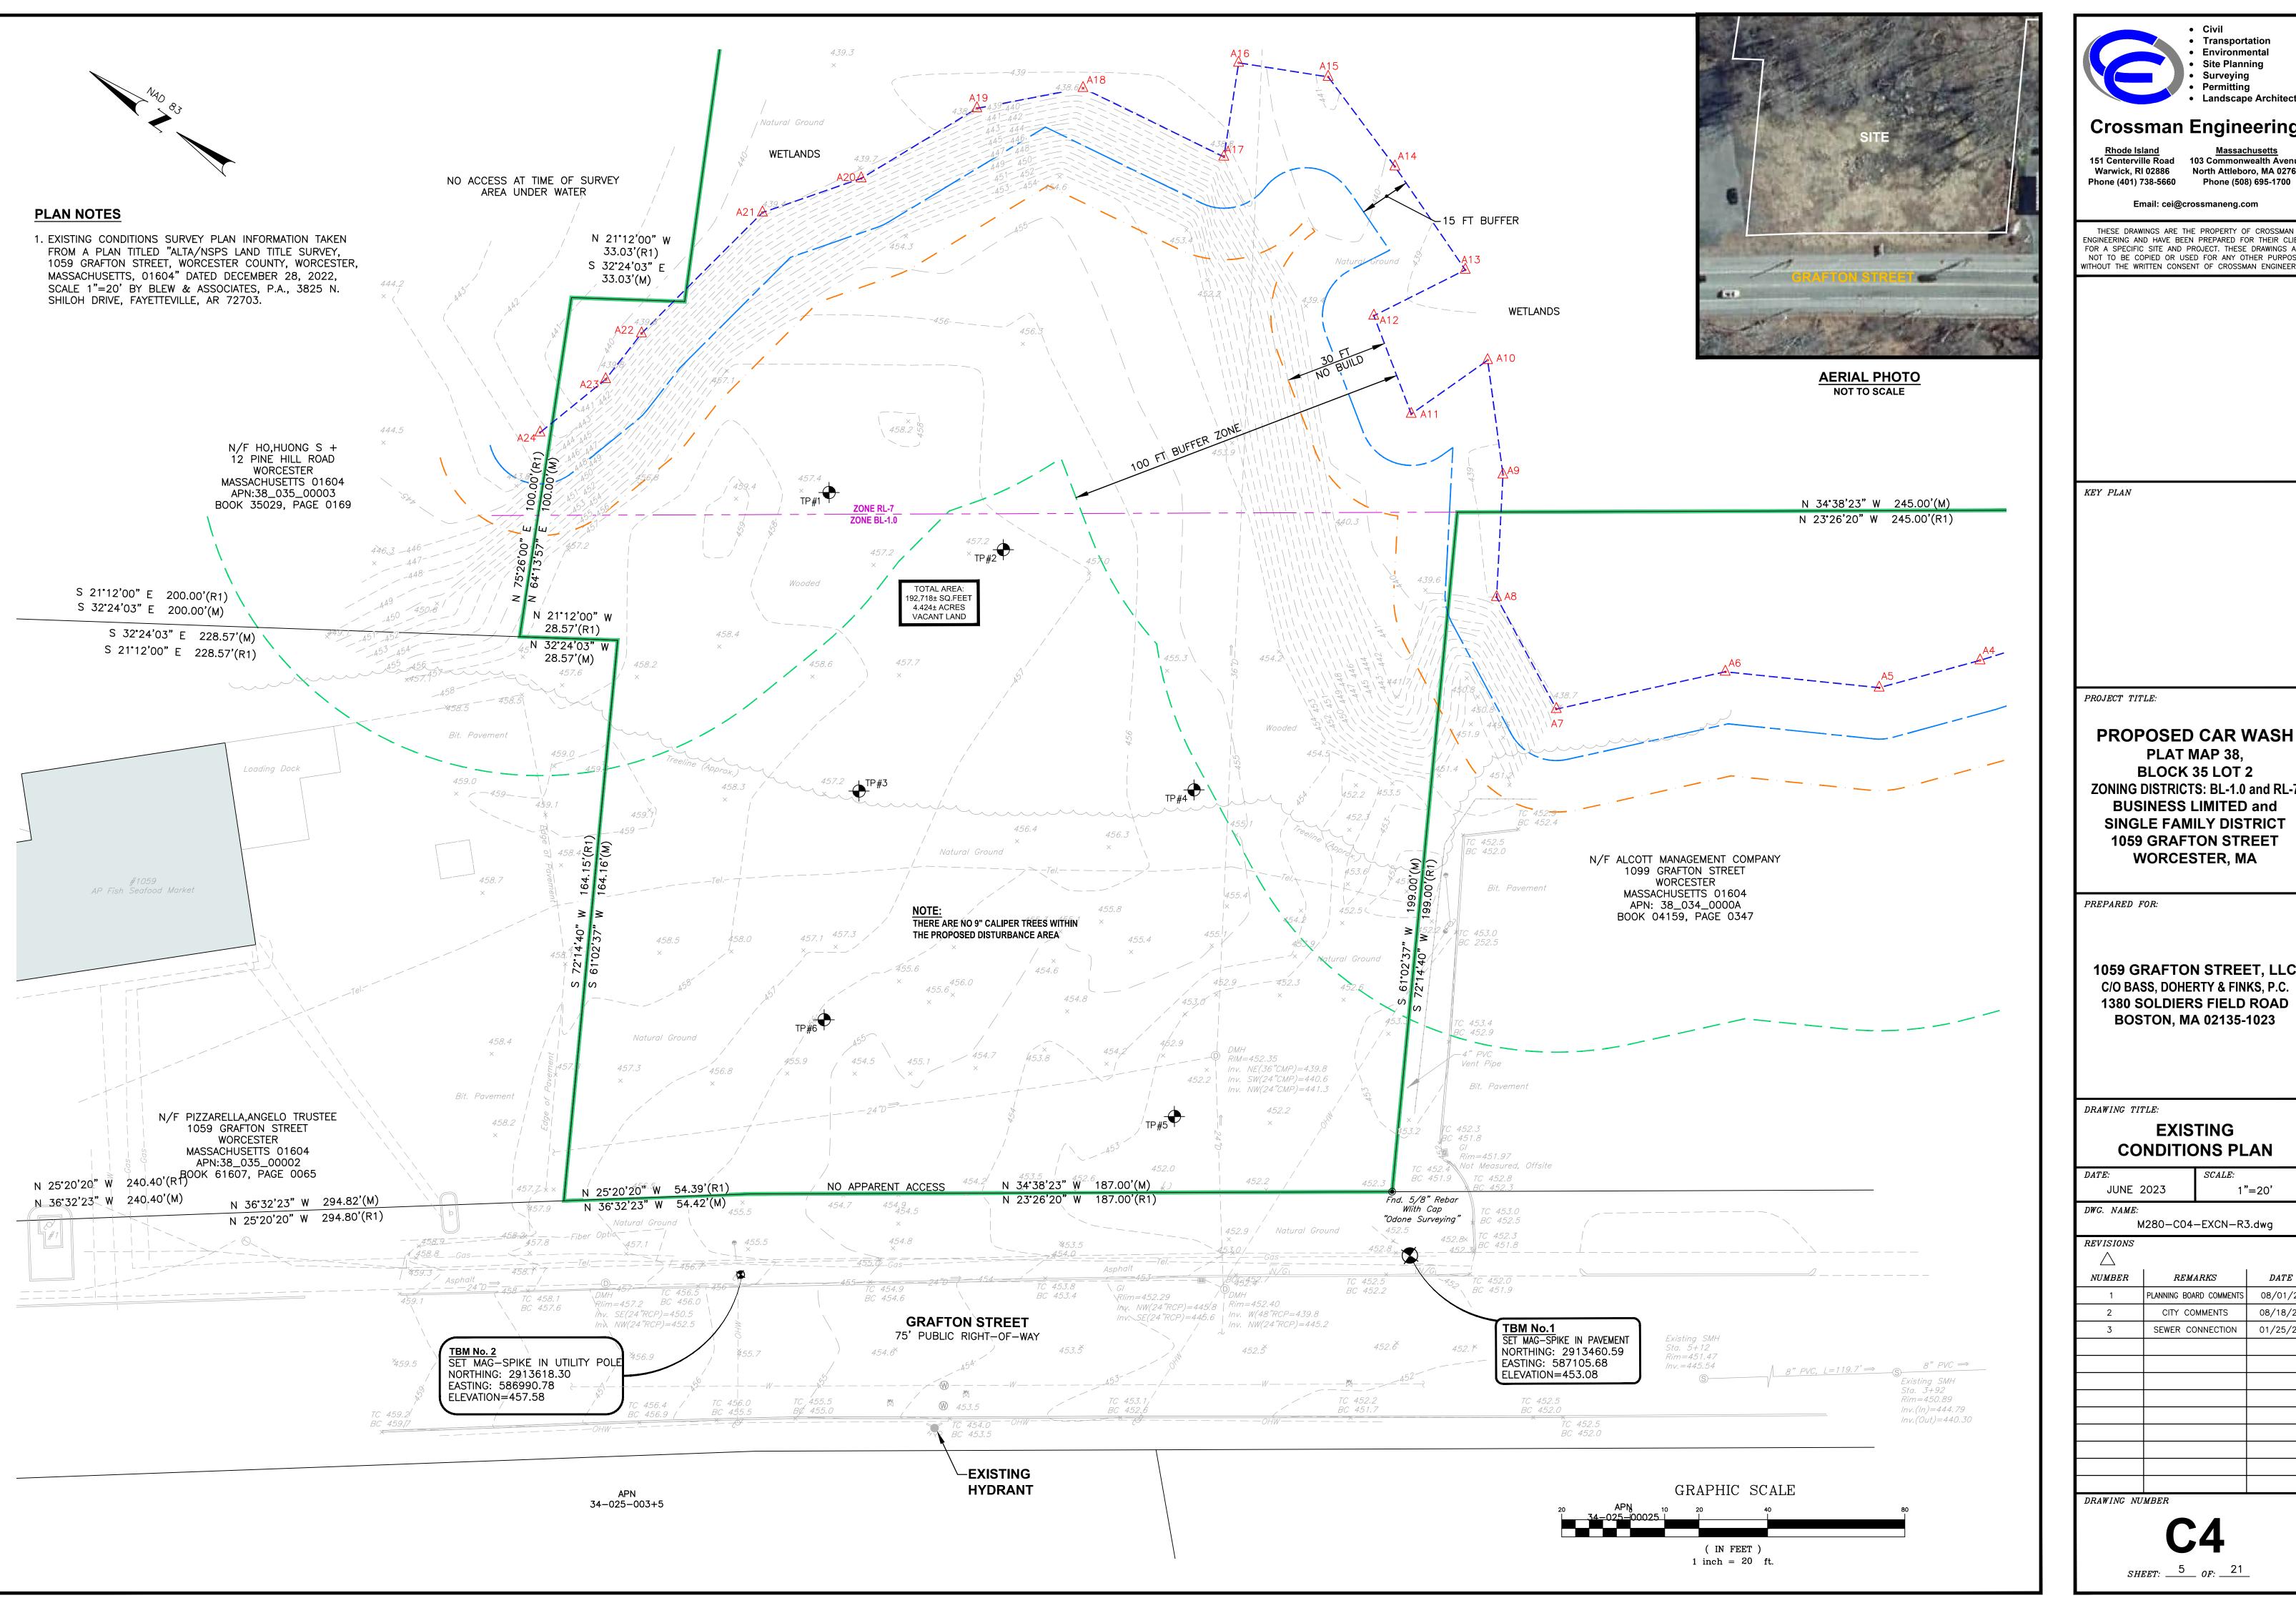



**Crossman Engineering** 

Civil

 Transportation Environmental Site Planning Surveying

Rhode Island Massachusetts
151 Centerville Road 103 Commonwealth Avenue Warwick, RI 02886 North Attleboro, MA 02763 Phone (401) 738-5660 Phone (508) 695-1700

Email: cei@crossmaneng.com

THESE DRAWINGS ARE THE PROPERTY OF CROSSMAN ENGINEERING AND HAVE BEEN PREPARED FOR THEIR CLIENT FOR A SPECIFIC SITE AND PROJECT. THESE DRAWINGS ARE NOT TO BE COPIED OR USED FOR ANY OTHER PURPOSE WITHOUT THE WRITTEN CONSENT OF CROSSMAN ENGINEERING

PROJECT TITLE:

PLAT MAP 38. BLOCK 35 LOT 2 **ZONING DISTRICTS: BL-1.0 and RL-7 BUSINESS LIMITED and** SINGLE FAMILY DISTRICT 1059 GRAFTON STREET **WORCESTER, MA** 

PREPARED FOR:

**1059 GRAFTON STREET, LLC** C/O BASS, DOHERTY & FINKS, P.C. 1380 SOLDIERS FIELD ROAD **BOSTON, MA 02135-1023** 

DRAWING TITLE:


## **EXISTING CONDITIONS PLAN**

1"=20' M280-C04-EXCN-R3.dwg

NUMBER REMARKS DATE

NUMBER	REMARKS	DATE
1	PLANNING BOARD COMMENTS	08/01/23
2	CITY COMMENTS	08/18/23
3	SEWER CONNECTION	01/25/24

DRAWING NUMBER

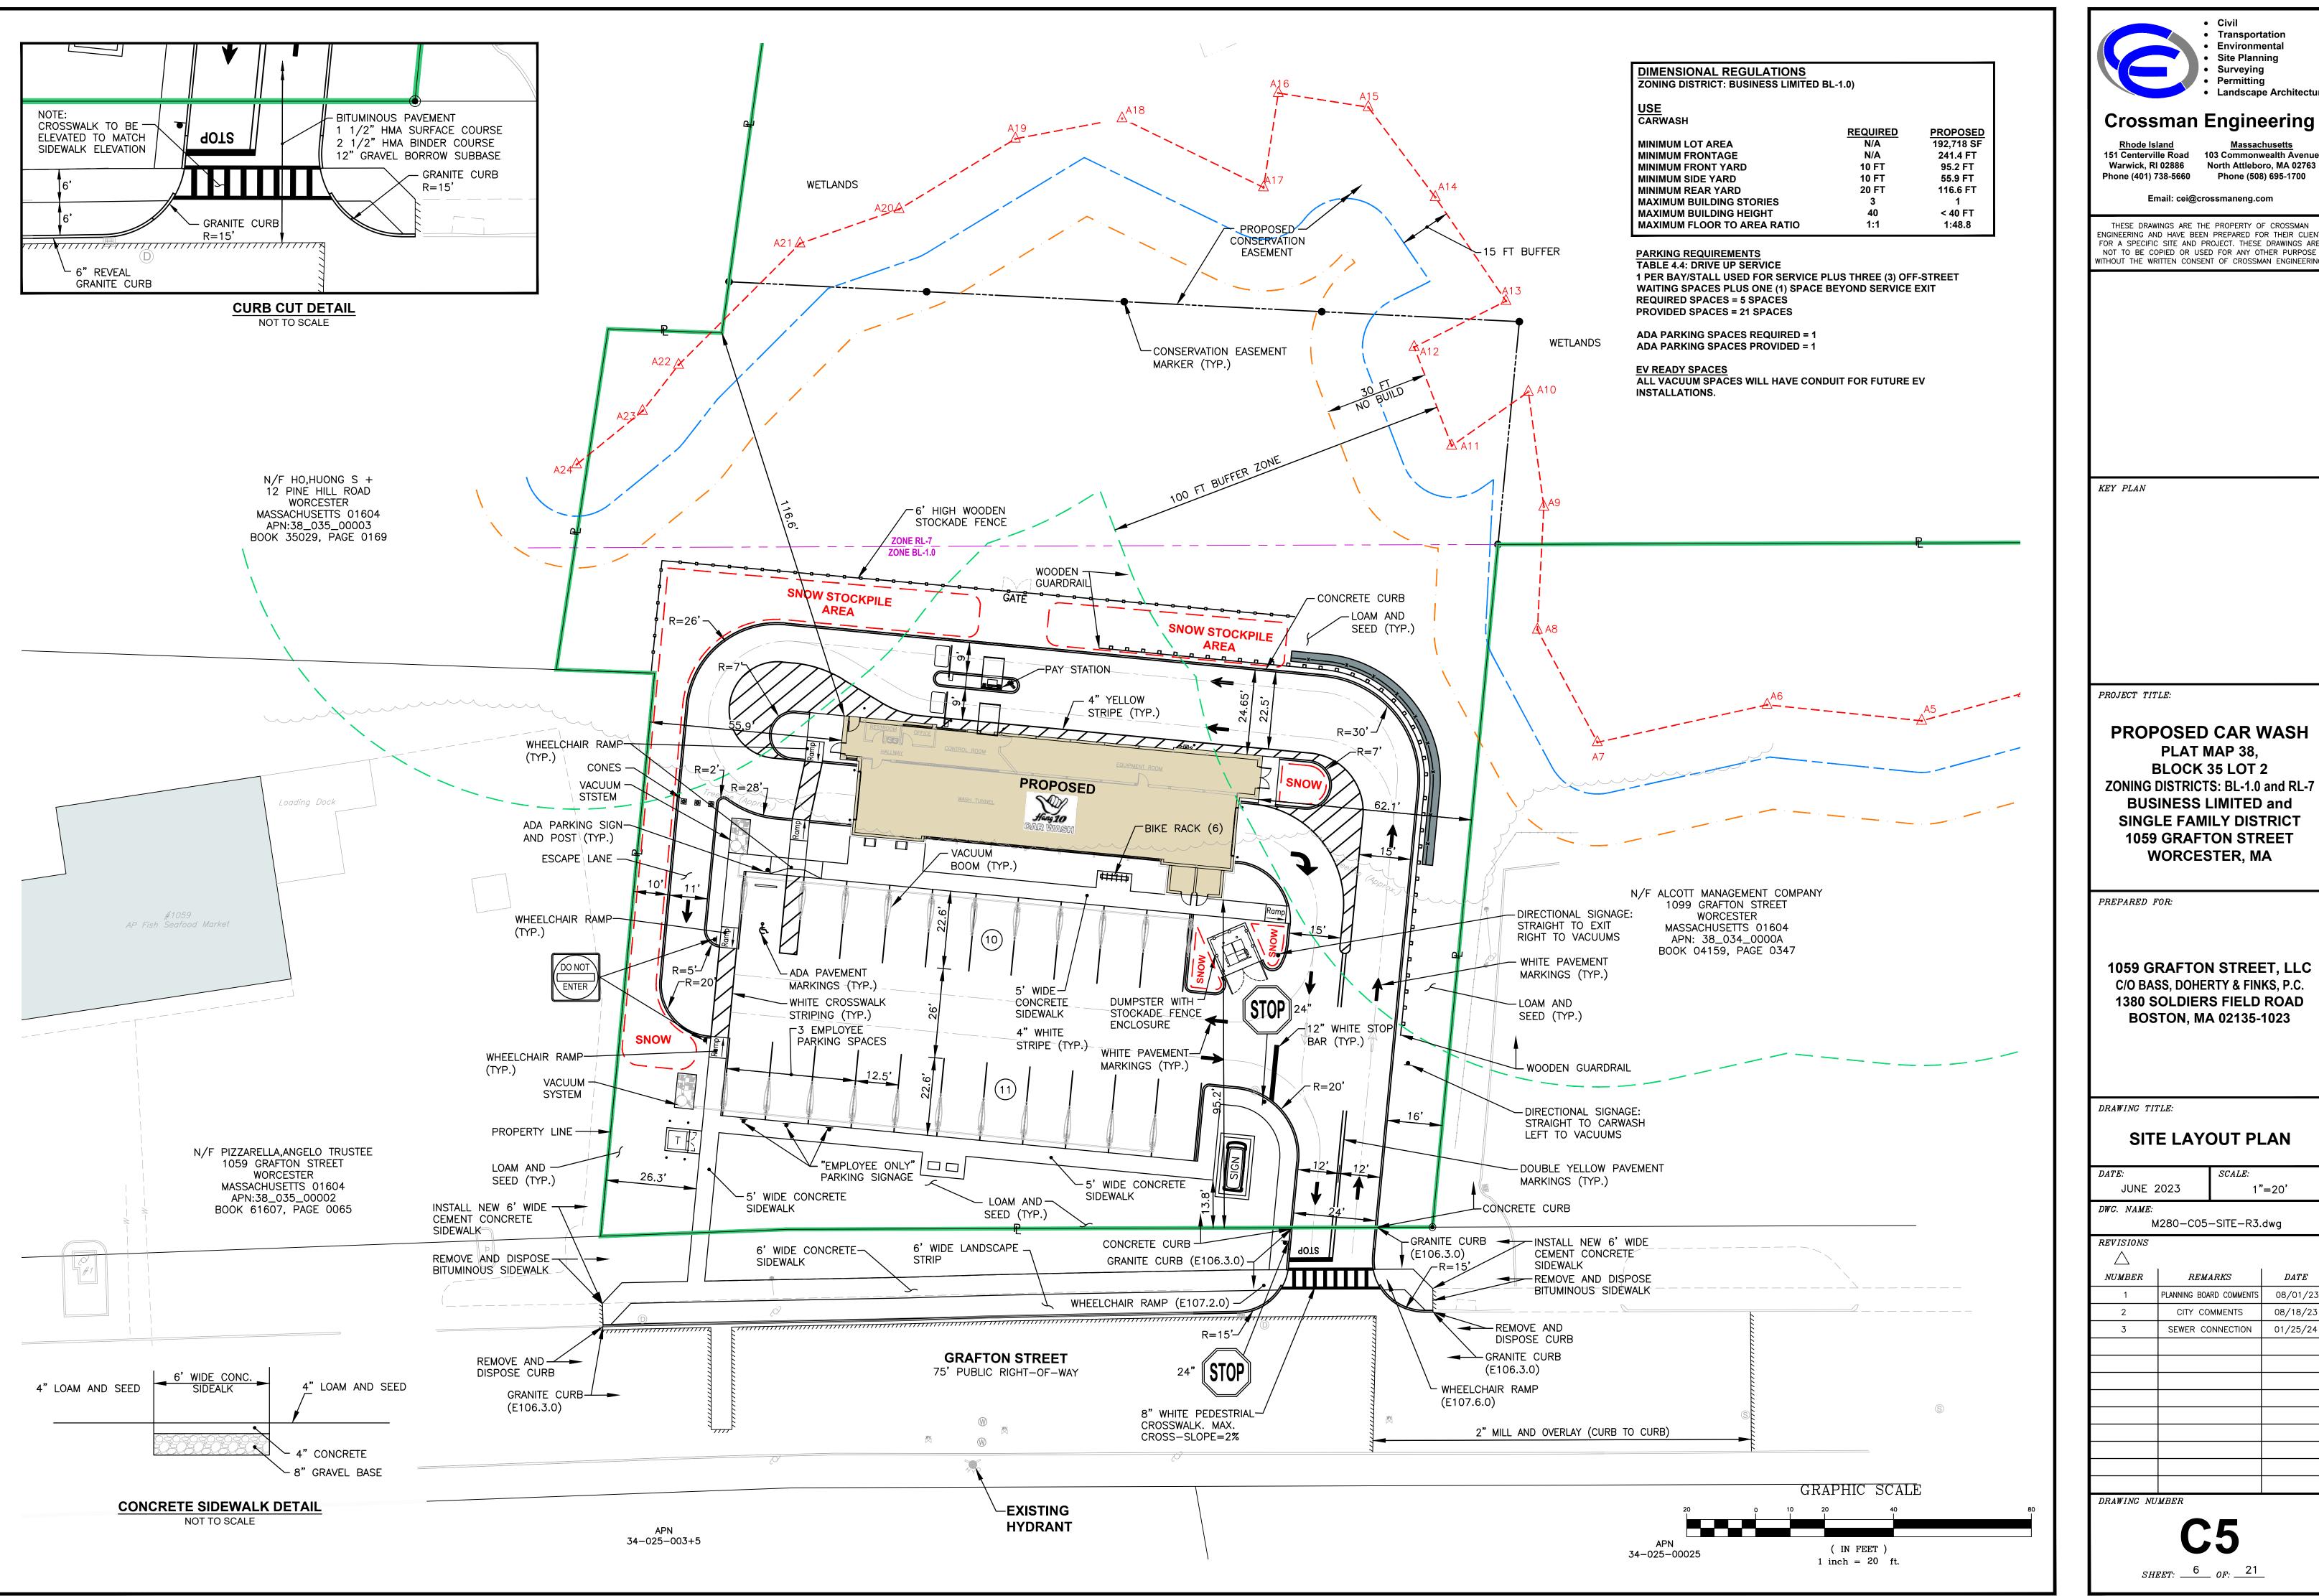

 Transportation Environmental Site Planning Surveying Permitting Landscape Architecture

# **Crossman Engineering**

Warwick, RI 02886 North Attleboro, MA 02763

Email: cei@crossmaneng.com

THESE DRAWINGS ARE THE PROPERTY OF CROSSMAN

ENGINEERING AND HAVE BEEN PREPARED FOR THEIR CLIENT FOR A SPECIFIC SITE AND PROJECT. THESE DRAWINGS ARE NOT TO BE COPIED OR USED FOR ANY OTHER PURPOSE WITHOUT THE WRITTEN CONSENT OF CROSSMAN ENGINEERING

PROPOSED CAR WASH PLAT MAP 38, BLOCK 35 LOT 2 **ZONING DISTRICTS: BL-1.0 and RL-7 BUSINESS LIMITED and** SINGLE FAMILY DISTRICT 1059 GRAFTON STREET


**1059 GRAFTON STREET, LLC** C/O BASS, DOHERTY & FINKS, P.C. 1380 SOLDIERS FIELD ROAD **BOSTON, MA 02135-1023** 

# SITE LAYOUT PLAN

1"=20' M280-C05-SITE-R3.dwg

REMARKS DATEPLANNING BOARD COMMENTS 08/01/23 CITY COMMENTS 08/18/23 SEWER CONNECTION 01/25/24

SHEET: 6 OF: 21

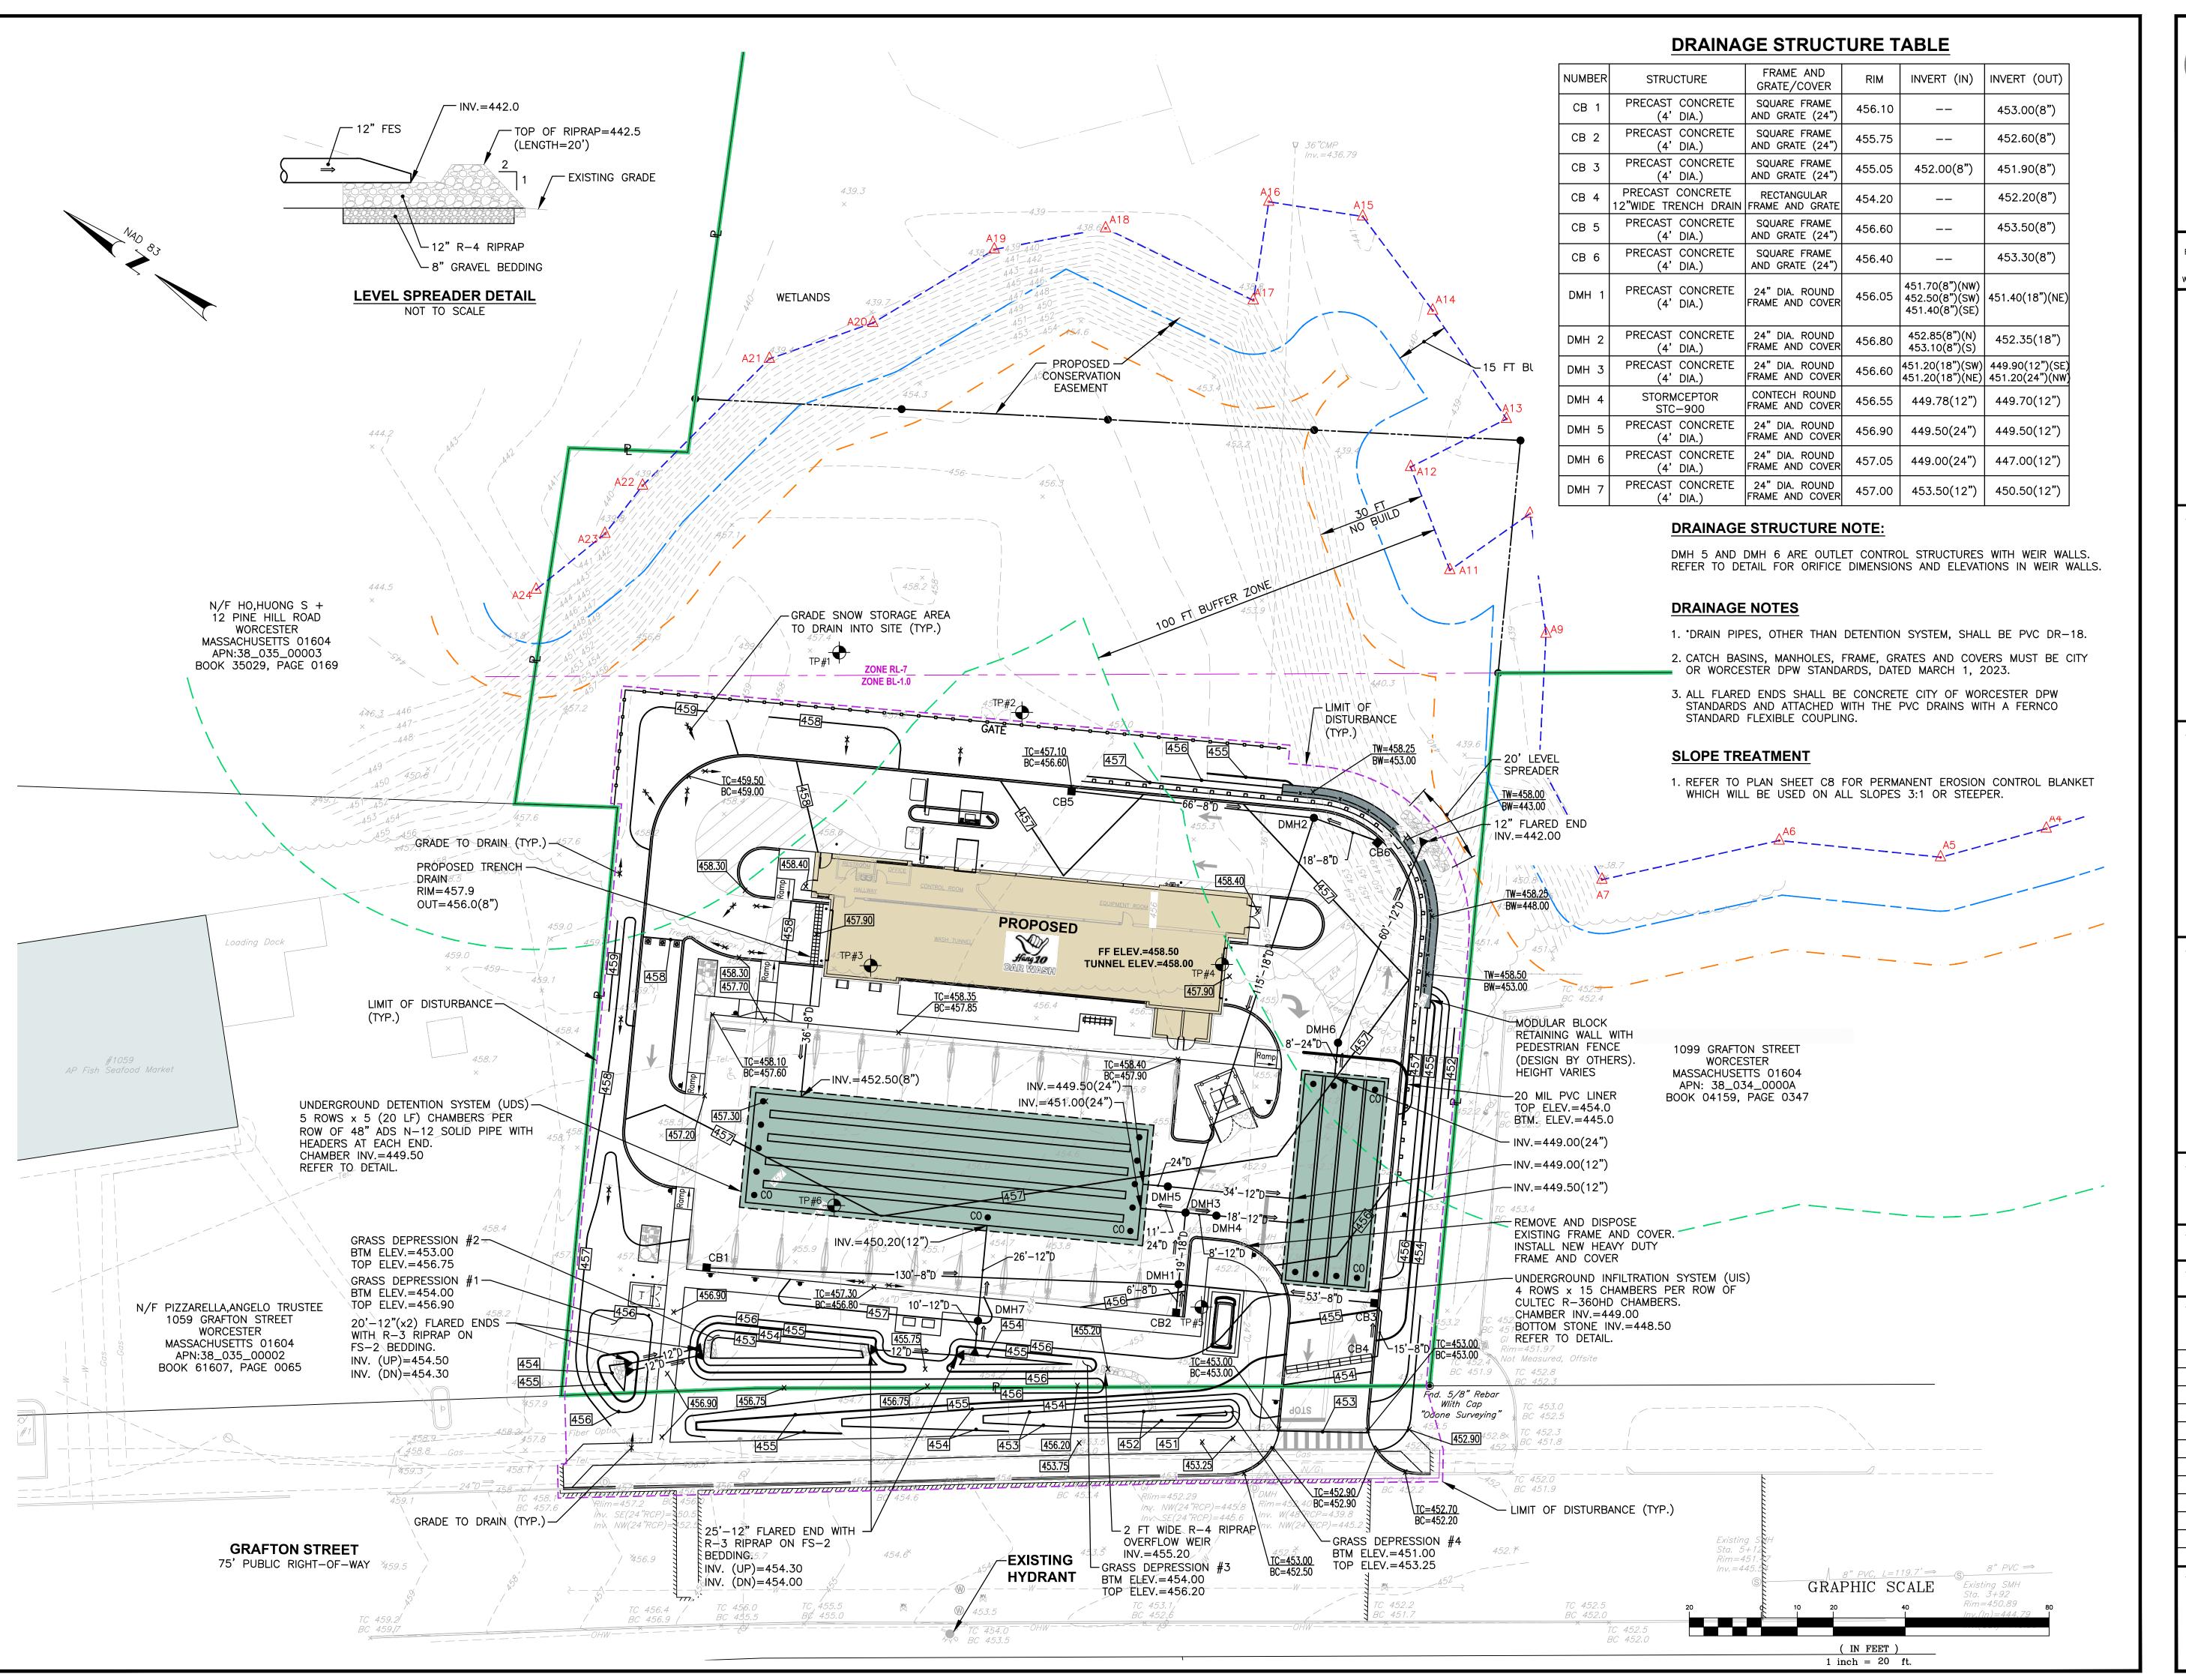



 Environmental Site Planning Surveying Permitting Landscape Architecture

Transportation

**Crossman Engineering** 

Phone (401) 738-5660 Phone (508) 695-1700

151 Centerville Road 103 Commonwealth Avenue Warwick, RI 02886 North Attleboro, MA 02763

Email: cei@crossmaneng.com

THESE DRAWINGS ARE THE PROPERTY OF CROSSMAN ENGINEERING AND HAVE BEEN PREPARED FOR THEIR CLIENT FOR A SPECIFIC SITE AND PROJECT. THESE DRAWINGS ARE NOT TO BE COPIED OR USED FOR ANY OTHER PURPOSE WITHOUT THE WRITTEN CONSENT OF CROSSMAN ENGINEERING

KEY PLAN

PROJECT TITLE:

PROPOSED CAR WASH PLAT MAP 38, BLOCK 35 LOT 2 ZONING DISTRICTS: BL-1.0 and RL-7 **BUSINESS LIMITED and** SINGLE FAMILY DISTRICT 1059 GRAFTON STREET

**WORCESTER, MA** 

PREPARED FOR:

**1059 GRAFTON STREET, LLC** C/O BASS, DOHERTY & FINKS, P.C. 1380 SOLDIERS FIELD ROAD **BOSTON, MA 02135-1023** 

DRAWING TITLE:

**GRADING** and **DRAINAGE PLAN** 


1"=20' JUNE 2023 DWG. NAME: M280-C06-GRADE-R3.dwg

REVISIONS

NUMBERREMARKS

DATEPLANNING BOARD COMMENTS 08/01/23 CITY COMMENTS 08/18/23 SEWER CONNECTION 01/25/24

DRAWING NUMBER

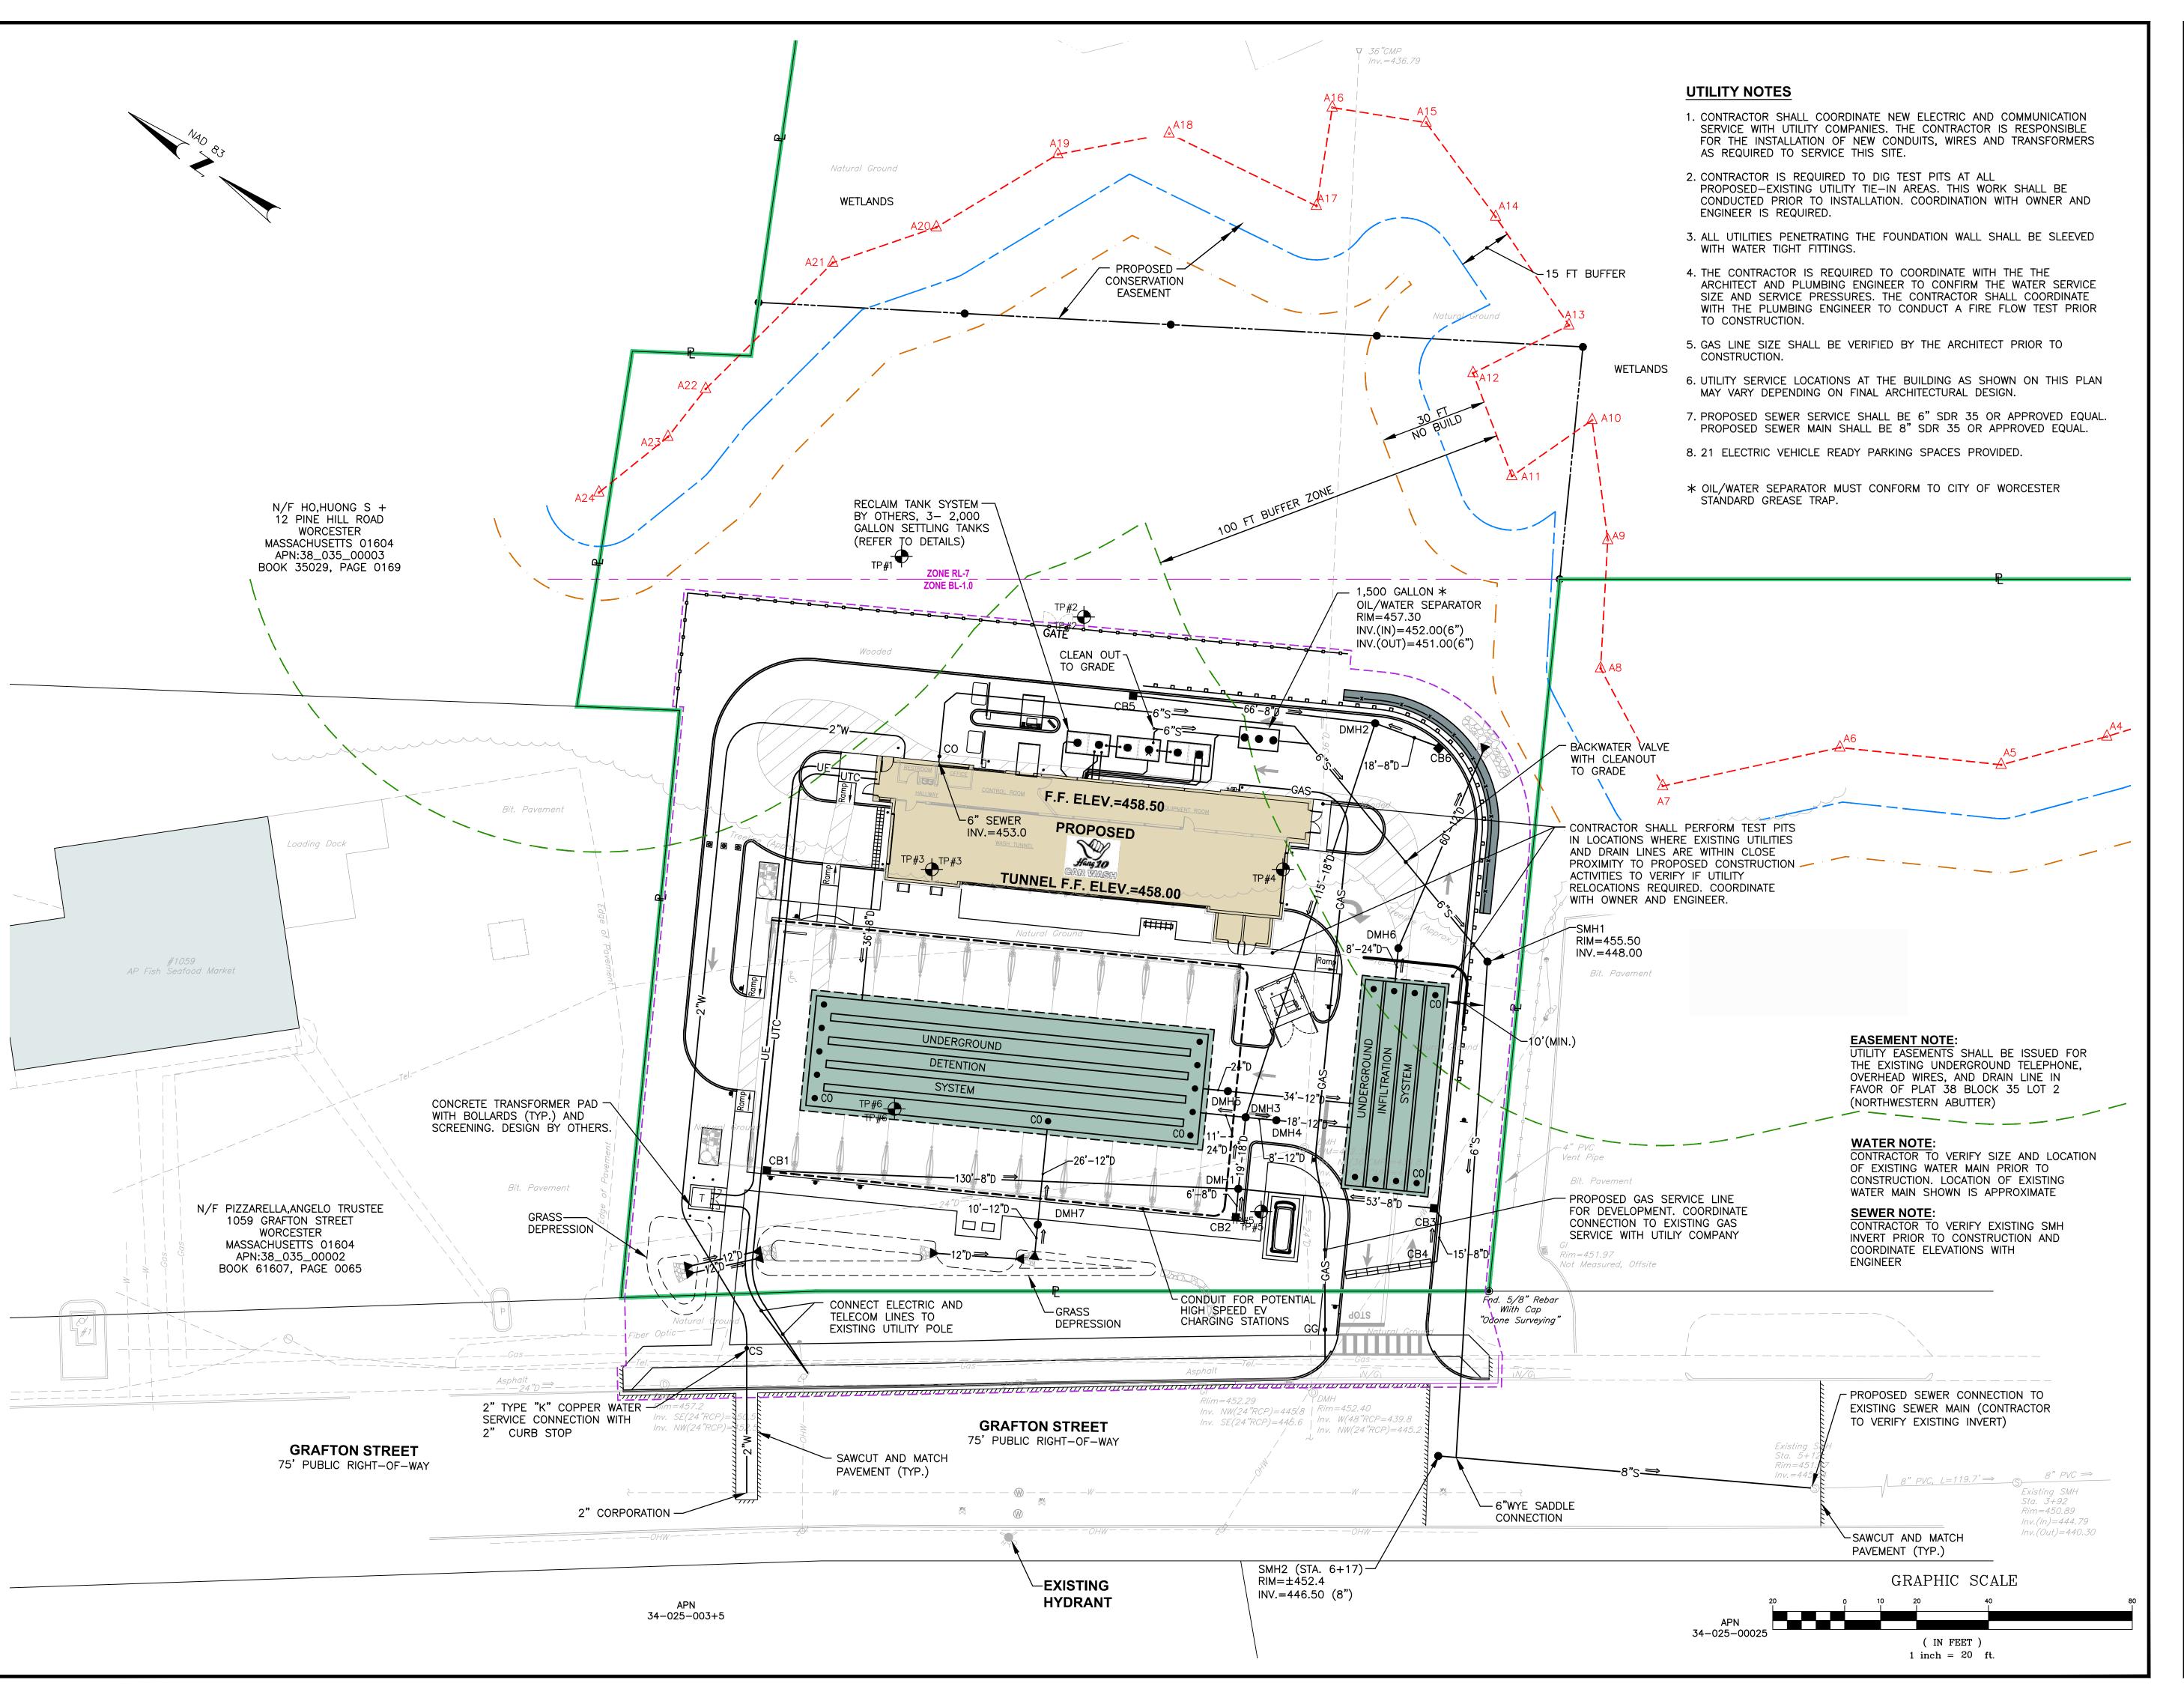



 Environmental Site Planning Surveying Permitting Landscape Architecture

Transportation

## Crossman Engineering

Civil

Phone (401) 738-5660 Phone (508) 695-1700

151 Centerville Road 103 Commonwealth Avenue Warwick, RI 02886 North Attleboro, MA 02763

Email: cei@crossmaneng.com

THESE DRAWINGS ARE THE PROPERTY OF CROSSMAN NGINEERING AND HAVE BEEN PREPARED FOR THEIR CLIENT FOR A SPECIFIC SITE AND PROJECT. THESE DRAWINGS ARE NOT TO BE COPIED OR USED FOR ANY OTHER PURPOSE WITHOUT THE WRITTEN CONSENT OF CROSSMAN ENGINEERING

KEY PLAN

PROJECT TITLE:

PROPOSED CAR WASH PLAT MAP 38, BLOCK 35 LOT 2 **ZONING DISTRICTS: BL-1.0 and RL-7 BUSINESS LIMITED and** SINGLE FAMILY DISTRICT 1059 GRAFTON STREET

WORCESTER, MA

PREPARED FOR:

**1059 GRAFTON STREET, LLC** C/O BASS, DOHERTY & FINKS, P.C. 1380 SOLDIERS FIELD ROAD **BOSTON, MA 02135-1023** 

DRAWING TITLE:

# **UTILITY PLAN**

1"=20'

DATE

DWG. NAME:

JUNE 2023

M280-C07-UTILITY-R3.dwg

REVISIONS


NUMBER

1	PLANNING BOARD COMMENTS	08/01/23
2	CITY COMMENTS	08/18/23
3	SEWER CONNECTION	01/25/24

REMARKS

DRAWING NUMBER

SHEET: 8 OF: 21

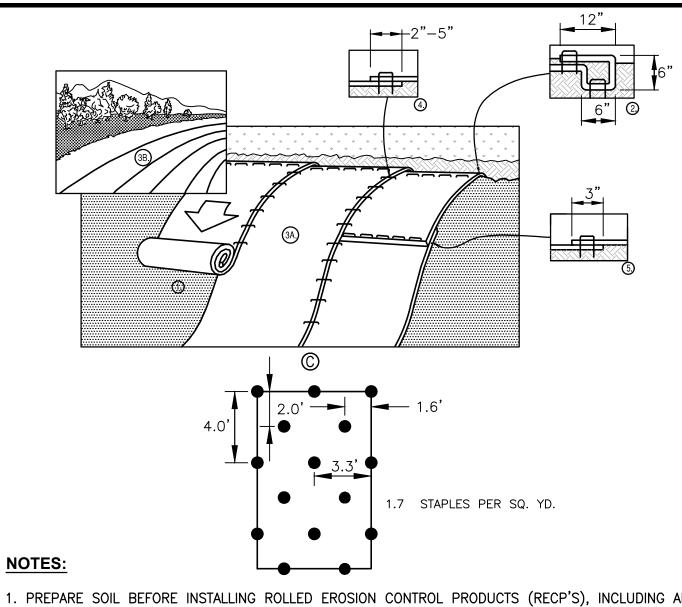

- PREPARE SOIL BEFORE INSTALLING ROLLED EROSION CONTROL PRODUCTS (RECP'S), INCLUDING ANY NECESSARY APPLICATION OF LIME FERTILIZER, AND SEED. NOTE: WHEN USING CELL-O-SEED DO NOT SEED PREPARED AREA. CELL-O-SEED MUST BE INSTALLED WITH PAPER SIDE DOWN.
- . BEGIN AT THE TOP OF THE SLOPE BY ANCHORING THE RECP'S IN A 6" (15 CM) DEEP X 6" (15 CM) WIDE TRENCH WITH APPROXIMATELY 12" (30CM) OF RECP'S EXTENDED BEYOND THE UP-SLOPE PORTION OF THE TRENCH. ANCHOR THE RECP'S WITH A ROW OF STAPLES/STAKES APPROXIMATELY 12" (30 CM) APART IN THE BOTTOM OF THE TRENCH. BACKFILL AND COMPACT THE TRENCH AFTER STAPLING. APPLY SEED TO COMPACTED SOIL AND FOLD REMAINING 12" (30 CM) PORTION OF RECP'S BACK OVER SEED AND COMPACTED SOIL. SECURE RECP'S OVER COMPACTED SOIL WITH A ROW OF STAPLES/STAKES SPACED APPROXIMATELY 12" (30 CM) APART ACROSS THE WIDTH OF THE RECP'S.
- 5. ROLL THE RECP'S (A.) DOWN OR (B.) HORIZONTALLY ACROSS THE SLOPE. RECP'S WILL UNROLL WITH APPROPRIATE SIDE AGAINST THE SOIL SURFACE. ALL RECP'S MUST BE SECURELY FASTENED TO SOIL SURFACE BY PLACING STAPLES/STAKES IN APPROPRIATE LOCATIONS AS SHOWN IN THE STAPLE PATTERN GUIDE. WHEN USING THE DOT SYSTEM<sup>TM</sup>, STAPLES/STAKES SHOULD BE PLACED THROUGH EACH OF THE COLORED DOTS CORRESPONDING TO THE APPROPRIATE STAPLE PATTERN.
- 4. THE EDGES OF PARALLEL RECP'S MUST BE STAPLED WITH APPROXIMATELY 2" 5" (5 CM 12.5 CM) OVERLAP DEPENDING ON RECP'S TYPE.
- 5. CONSECUTIVE RECP'S SPLICED DOWN THE SLOPE MUST BE PLACED END OVER END (SHINGLE STYLE) WITH AN APPROXIMATE 3" (7.5 CM) OVERLAP. STAPLE THROUGH OVERLAPPED AREA, APPROXIMATELY 12" (30 CM) APART ACROSS ENTIRE RECP'S WIDTH.
- 6. ALL REQUIRED EROSION CONTROL BLANKET (MAT) OVERLAPS AND ANCHORS SHALL BE INCLUDED IN THE CONTRACTOR'S BID PRICE.

NOTE: \*IN LOOSE SOIL CONDITIONS, THE USE OF STAPLE OR STAKE LENGTHS GREATER THAN 6" (15 CM) MAY BE NECESSARY TO PROPERLY SECURE THE RECP'S.

#### **EROSION CONTROL BLANKET (MAT)** PERMANENT AND TEMPORARY INSTALLATION DETAIL

NOT TO SCALE

#### INSPECTION/MAINTENANCE NOTES

- . PRIOR TO COMMENCING CLEARING AND GRUBBING OPERATIONS, PERIMETER EROSION CONTROLS SHALL BE PLACED SO AS TO PREVENT SEDIMENT FROM ENTERING EXISTING ROADWAY DRAINAGE SYSTEM. WETLANDS AND ABUTTING PROPERTIES.
- 2. EXTREME CARE SHALL BE EXERCISED SO AS TO PREVENT ANY UNSUITABLE MATERIAL FROM ENTERING THE ROADWAY DRAINAGE SYSTEM.
- 3. ALL DISTURBED AREAS WHICH BECOME SUBJECT TO EROSIVE TENDENCIES WHETHER THEY BE NEWLY FILLED OR EXCAVATED SHALL RECEIVE SLOPE PROTECTION - SUCH AS RIP-RAP.
- DURING PERIODS OF RAINFALL. 5. DURING CONSTRUCTION, THE CONTRACTOR SHALL BE RESPONSIBLE FOR ALL EROSION CONTROL MAINTENANCE AND

4. DURING CONSTRUCTION, THE CONTRACTOR SHALL BE RESPONSIBLE FOR MAINTAINING DRAINAGE AND RUNOFF FLOW

- SHALL INSPECT/REPLACE DAILY DURING CONSTRUCTION, FOLLOWING RAINFALL AND WEEKLY DURING NON CONSTRUCTION
- TOWN'S REPRESENTATIVE. 7. THE LATEST VERSION OF THE "MASSACHUSETTS EROSION AND SEDIMENT CONTROL GUIDELINES FOR URBAN AND

6. ADDITIONAL EROSION CONTROLS SHALL BE LOCATED AS CONDITIONS WARRANT OR AS DIRECTED BY THE ENGINEER OR


- SUBURBAN AREAS HANDBOOK" PREPARED BY THE DEPARTMENT OF ENVIORONMENTAL PROTECTION MUST BE UTILIZED BY THE CONTRACTOR AS A GUIDE.
- 8. THE CONTRACTOR IS RESPONSIBLE FOR ALL DUST CONTROL AND FOR THE ENTIRE PROJECT DURATION, INCLUDING TEMPORARY SHUT-DOWN PERIODS, MUST MONITOR AND REPAIR, AS NEEDED, ALL SURFACES TO ENSURE A STABLE

## **DUST CONTROL NOTES**

- ON AN AS-NEEDED BASIS OR AS DIRECTED BY THE TOWN, THE CONTRACTOR SHALL UTILIZE ONE OF THE FOLLOWING METHODS TO CONTROL DUST:
- A. THE EXPOSED SOIL SURFACE SHOULD BE MOISTENED PERIODICALLY WITH ADEQUATE WATER TO CONTROL DUST.
- CALCIUM CHLORIDE SHOULD BE EITHER LOOSE DRY GRANULES OR FLAKES FINE ENOUGH TO FEED THROUGH A SPREADER AT A RATE THAT WILL KEEP SURFACE MOIST BUT NOT CAUSE POLLUTION OR PLANT DAMAGE.

# **GENERAL PROJECT WIDE NOTES**

- . ALL EXISTING AND PROPOSED DRAINAGE STRUCTURES WITHIN THE PROJECT LIMITS SHALL BE FITTED WITH SILT SACKS OR APPROVED EQUAL.
- 12" COMPOST FILTER SOCK, SILT FENCE, OR APPROVED EQUAL SHALL BE INSTALLED AT THE LOCATIONS SHOWN. ADDITIONAL SILT FENCE OR EROSION CONTROLS SHALL BE INSTALLED WHERE NEEDED TO PREVENT SEDIMENT FROM LEAVING THE CONSTRUCTION SITE.
- 3. THE CONTRACTOR MUST REPLACE AND/OR RESEED ANY VEGETATION THAT DOES NOT DEVELOP/SURVIVE WITHIN THE PERIOD OF ONE YEAR AND HE SHALL DO SO AT NO ADDITIONAL EXPENSE TO THE OWNER.
- 4. ALL SOIL EROSION AND SEDIMENT CONTROLS SHALL REMAIN IN PLACE UNTIL AN ACCEPTABLE STAND OF GRASS OR APPROVED GROUND COVER IS ESTABLISHED AND POTENTIAL SEDIMENTATION SOURCES ARE REMOVED.
- 5. TREES AND OTHER EXISTING VEGETATION SHALL BE RETAINED WHENEVER FEASIBLE; THE AREA BEYOND THE DROPLINE SHALL BE FENCED OR ROPED OFF TO PROTECT TREES FROM CONSTRUCTION EQUIPMENT.
- 3. AREAS DAMAGED DURING CONSTRUCTION SHALL BE RESODDED, RESEEDED, OR OTHERWISE RESTORED AT THE CONTRACTOR'S EXPENSE.
- 7. STOCKPILES SHALL HAVE NO SLOPE STEEPER THAN 2:1 AND SHALL BE SURROUNDED BY STAKED FILTER SOCK.
- B. STOCKPILES EXPOSED FOR EXCESSIVE PERIODS SHALL RECEIVE TEMPORARY TREATMENT CONSISTING OF HAY, STRAW, FIBER MATTING OR APPROVED EQUAL.
- 9. SILT FENCE OR STAKED HAYBALES MAY BE USED IN LIEU OF THE COMPOST FILTER SOCK.

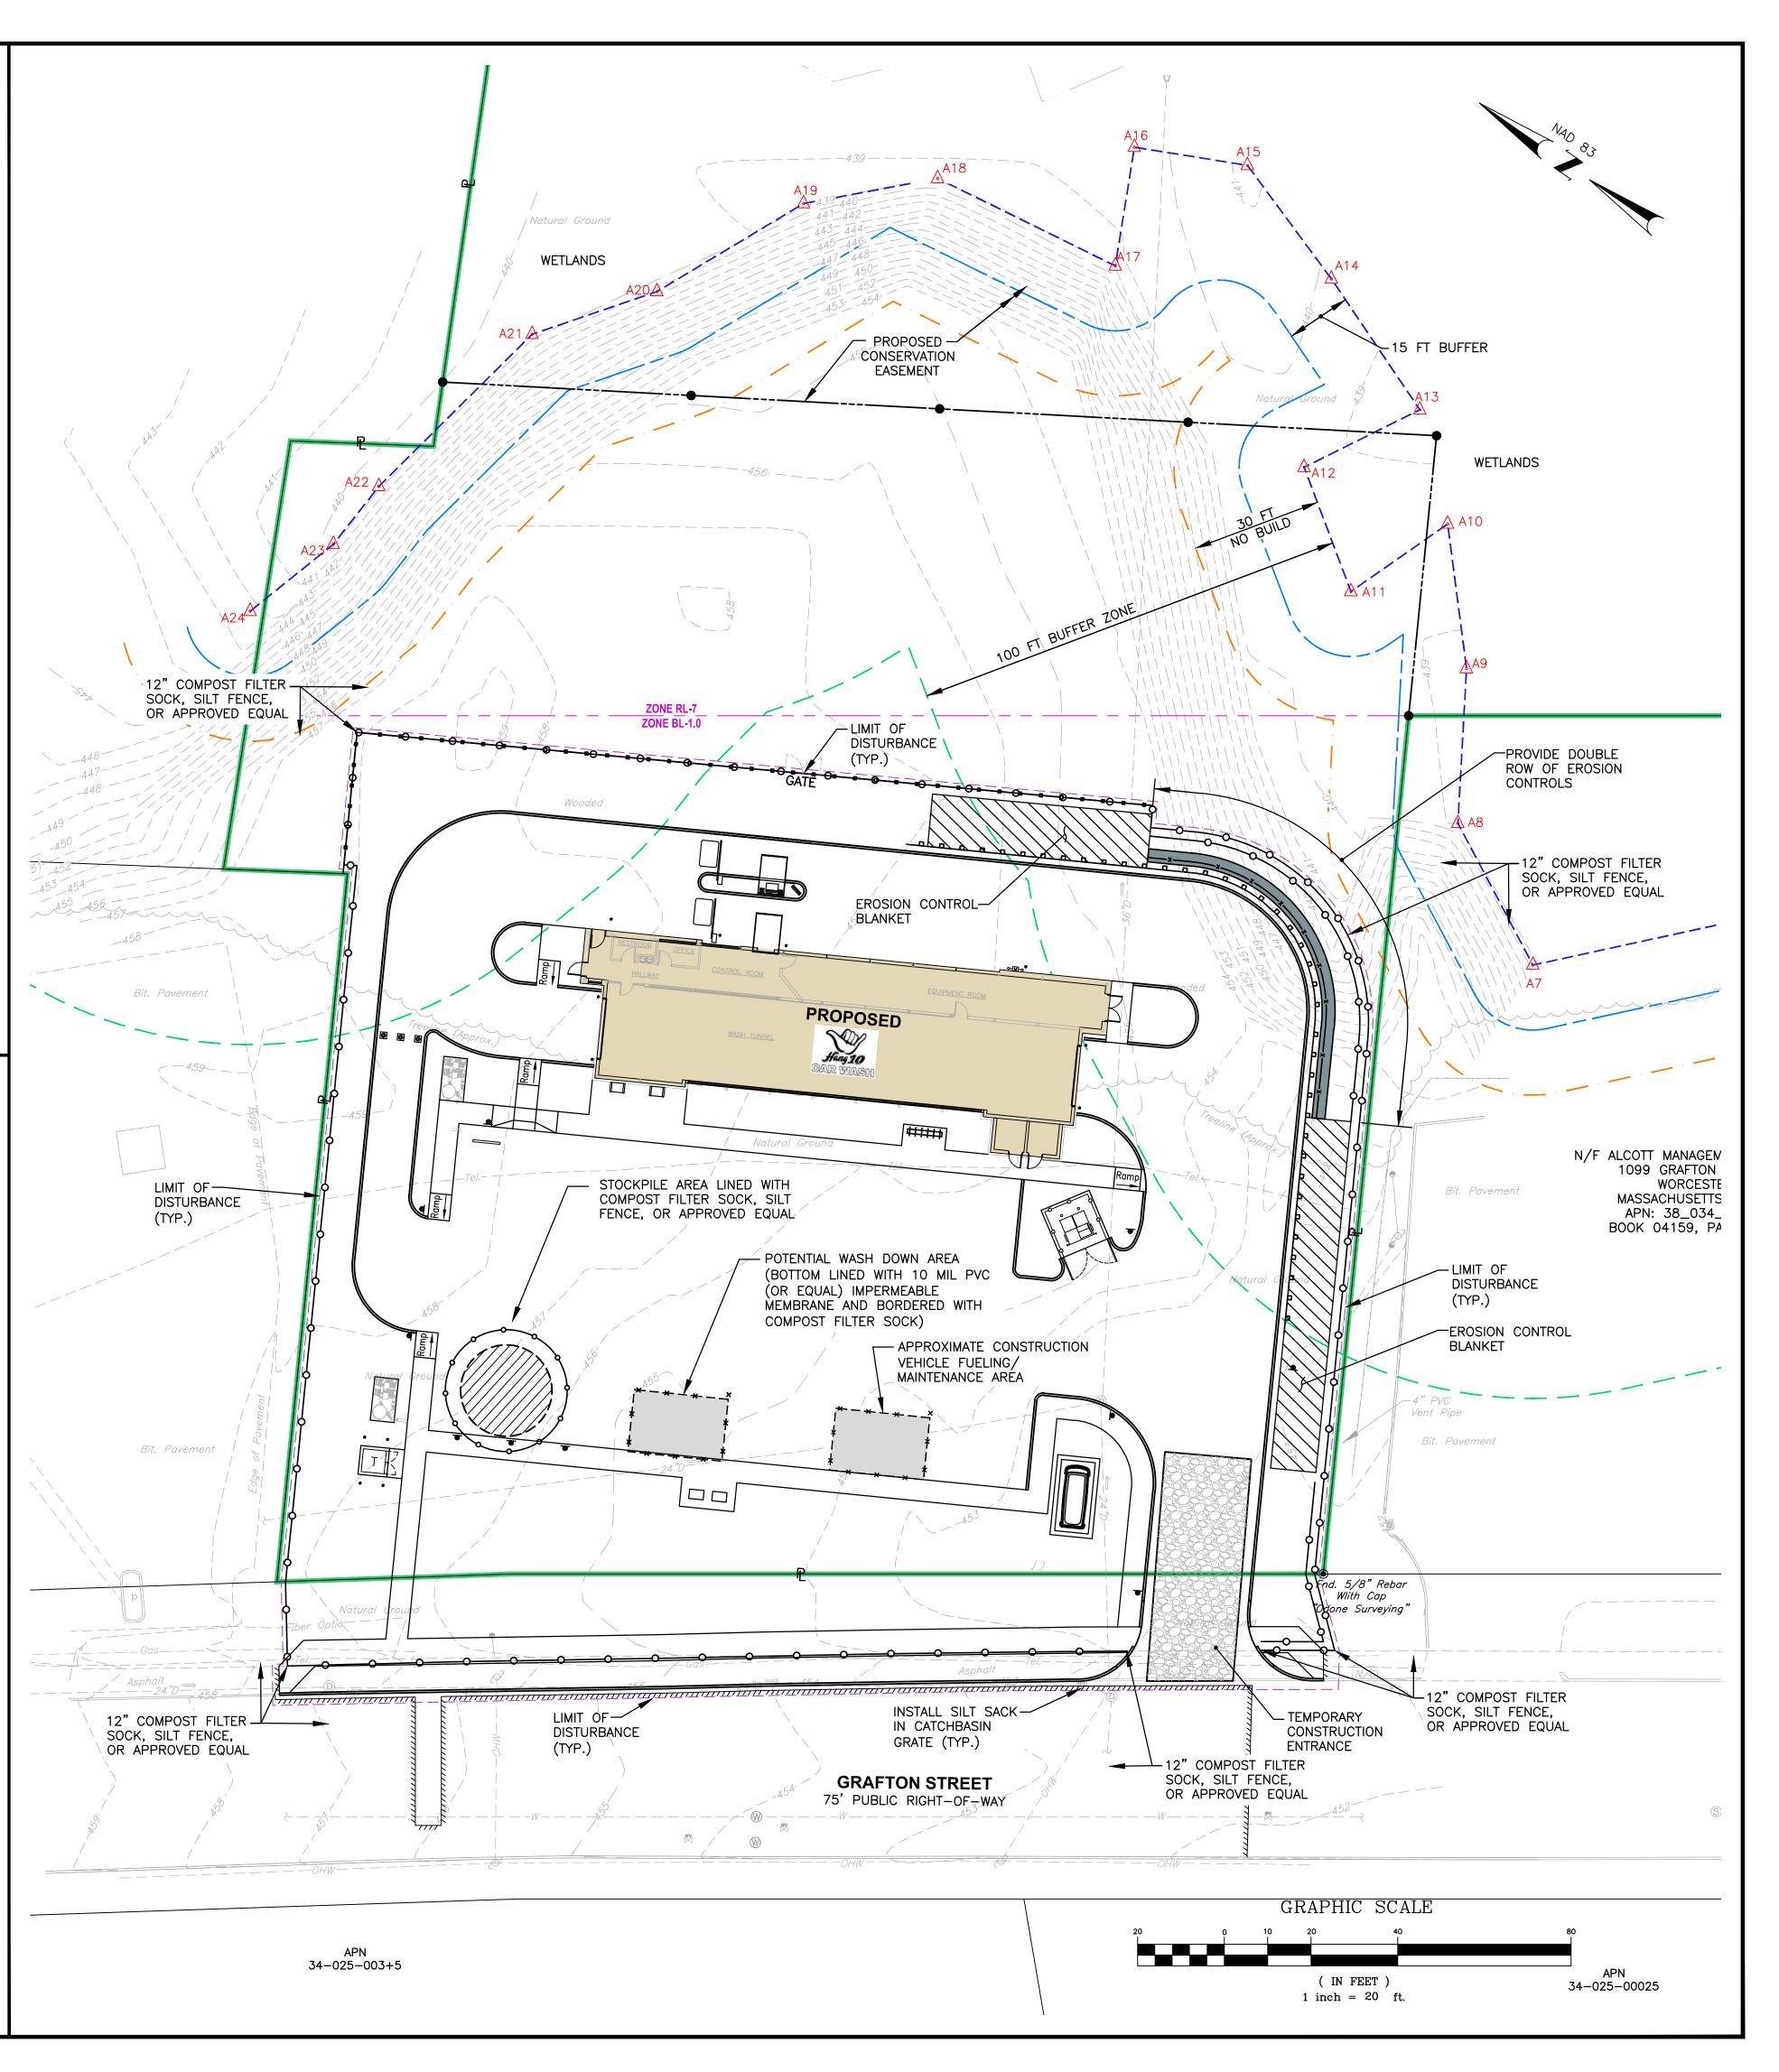



Surveying Permitting Landscape Architecture

 Environmental Site Planning

Crossman Engineering 151 Centerville Road 103 Commonwealth Avenue

Warwick, RI 02886 North Attleboro, MA 02763 Phone (401) 738-5660 Phone (508) 695-1700

Email: cei@crossmaneng.com

THESE DRAWINGS ARE THE PROPERTY OF CROSSMAN NGINEERING AND HAVE BEEN PREPARED FOR THEIR CLIEN FOR A SPECIFIC SITE AND PROJECT. THESE DRAWINGS ARI NOT TO BE COPIED OR USED FOR ANY OTHER PURPOSE WITHOUT THE WRITTEN CONSENT OF CROSSMAN ENGINEERIN

KEY PLAN

PROJECT TITLE:

PROPOSED CAR WASH PLAT MAP 38, BLOCK 35 LOT 2 ZONING DISTRICTS: BL-1.0 and RL-7 **BUSINESS LIMITED and** SINGLE FAMILY DISTRICT 1059 GRAFTON STREET

**WORCESTER, MA** 

PREPARED FOR:

1059 GRAFTON STREET. LLC C/O BASS, DOHERTY & FINKS, P.C. 1380 SOLDIERS FIELD ROAD **BOSTON, MA 02135-1023** 

DRAWING TITLE:

**SOIL EROSION and** SEDIMENT CONTROL PLAN

1"=20" JUNE 2023 DWG. NAME:


M280-C08-SOIL-R3.dwg


*REVISIONS* 

NUMBERREMARKS DATEPLANNING BOARD COMMENTS | 08/01/23 CITY COMMENTS 08/18/23 SEWER CONNECTION 01/25/24

DRAWING NUMBER

SHEET: 9 OF: 21

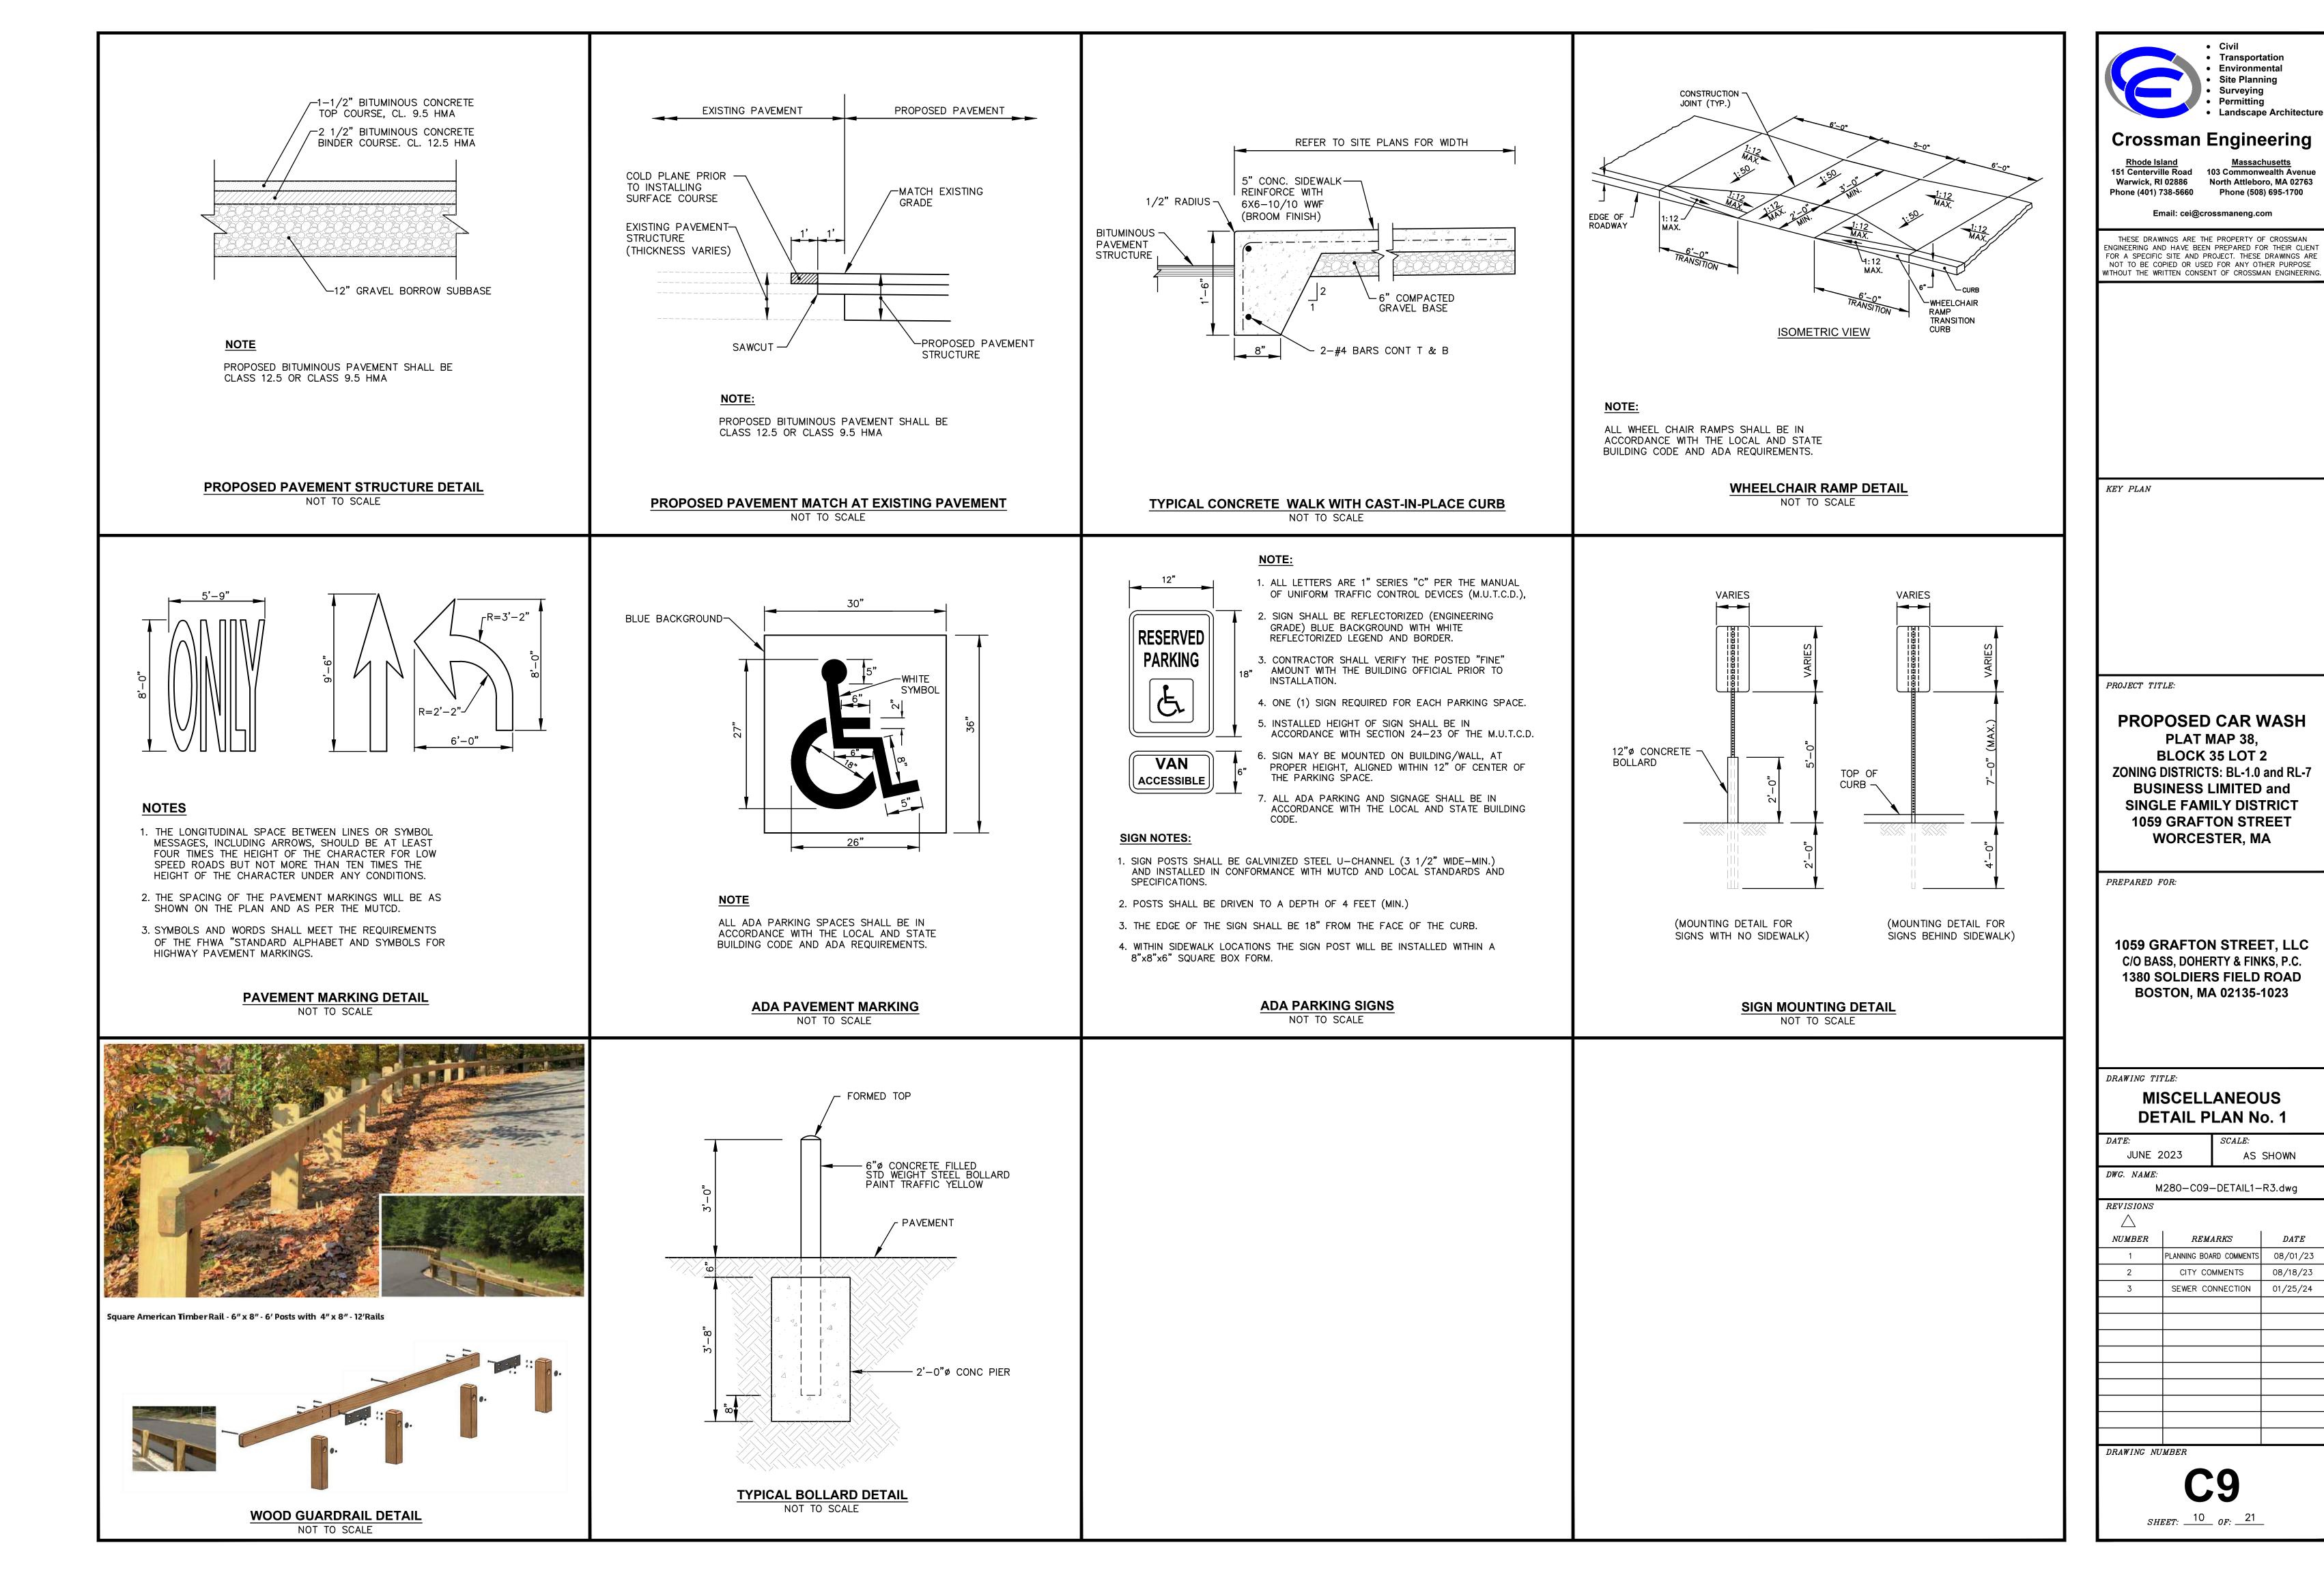

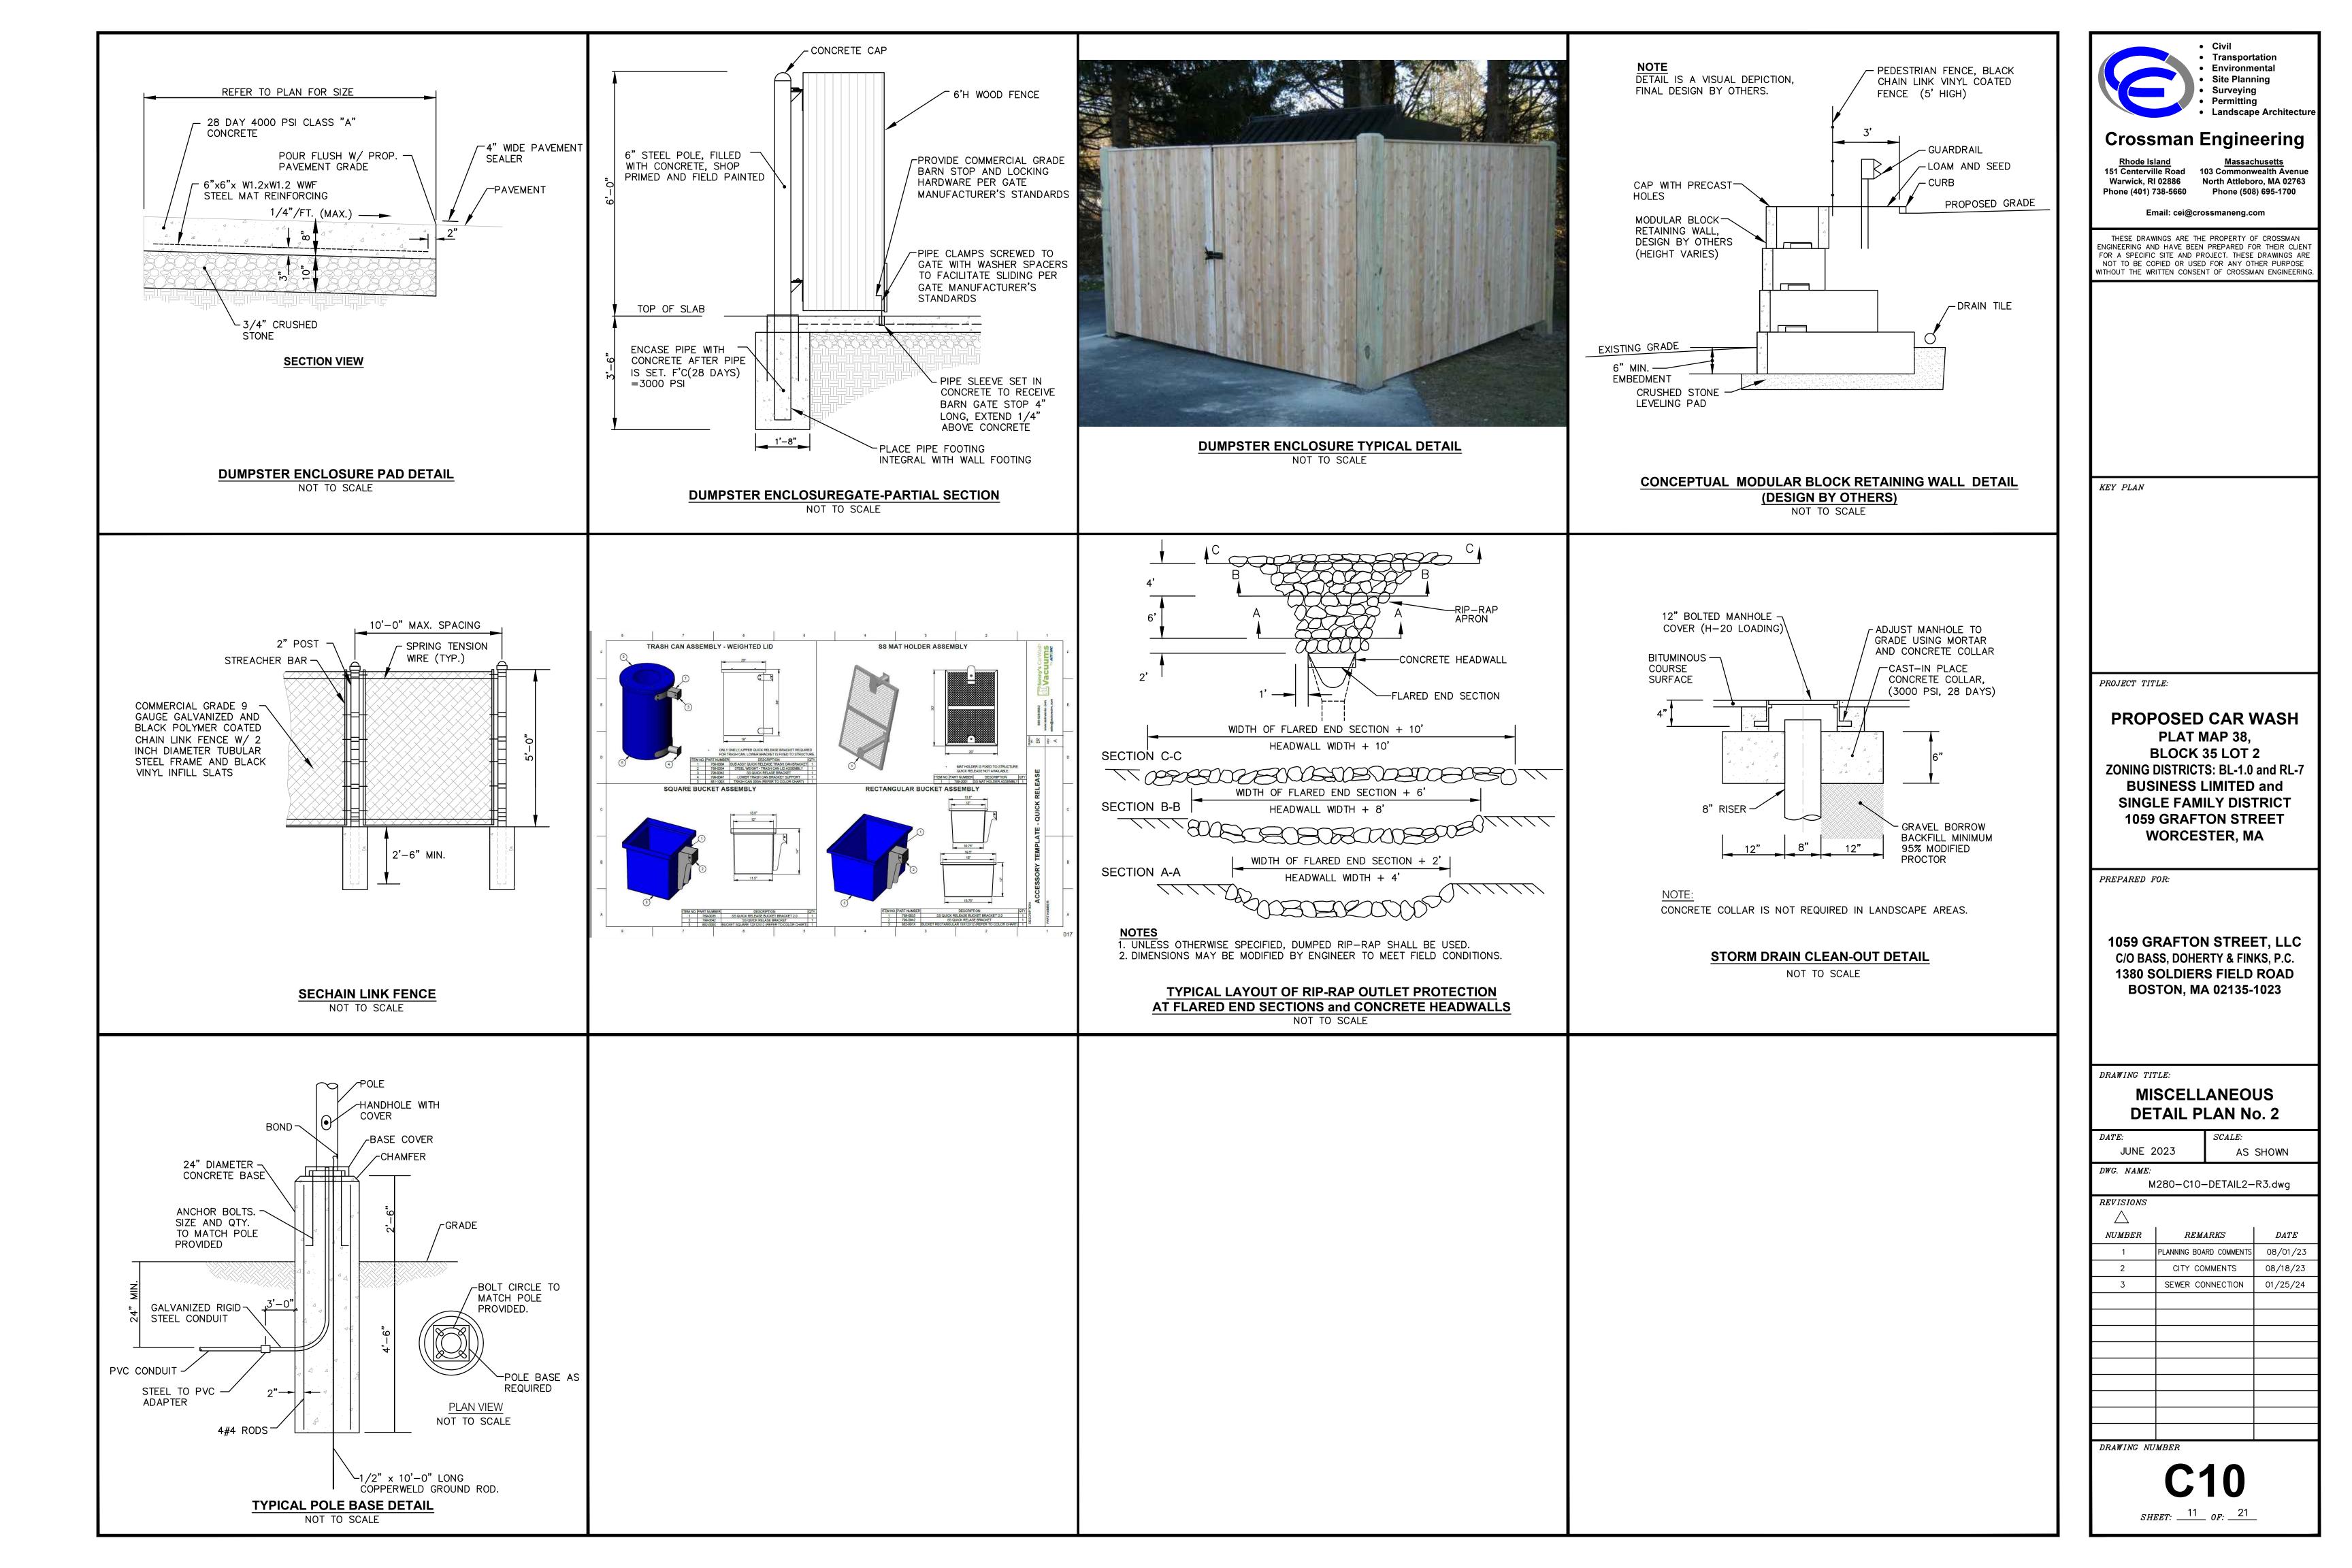


#### DRAINAGE NOTES

- . CONTRACTOR TO VERIFY THAT ALL STRUCTURES ARE COMPATIBLE WITH FRAME AND GRATE.
- 2. CONTRACTOR IS RESPONSIBLE TO PROVIDE SHOP DRAWINGS AND SPECIFICATIONS FOR ALL DRAINAGE RELATED ITEMS FOR REVIEW AND APPROVAL BY THE ENGINEER, PRIOR TO ORDERING. CONCRETE MANUFACTURER SHALL REVIEW RIM TO TOP OF PIPE ELEVATIONS AND PROVIDE SPECIFIC DETAILS.
- 3. ALL STRUCTURES SHALL BE DESIGNED FOR H-20 LOADING.
- 4. ALL CATCH BASINS SHALL BE PRECAST CONCRETE WATER TIGHT STRUCTURES. (NO WEEP HOLES)
- 5. UNLESS OTHERWISE NOTED, ALL SOLID DRAINAGE PIPE SHALL BE ADS N-12 HDPE OR APPROVED EQUAL. PIPE BEDDING SHALL BE IN CRUSHED STONE OR GRAVEL BORROW COMPACTED TO 95% DRY DENSITY (MODIFIED PROCTOR METHOD). ADS PIPE SHALL BE INSTALLED ACCORDING TO MANUFACTURERS' REQUIREMENTS. PIPES SHALL BE INSTALLED WITH CLAY TRENCH DAMS EVERY 50' (MINIMUM 1 PER PIPE).
- 5. GRADES WITHIN HANDICAP ACCESSIBLE PARKING SPACES AND AISLES SHALL NOT BE LESS THAN 1% OR GREATER THAN 2%.
- . CONTRACTOR MAY NEED TO RELOCATE PIPE TO AVOID CONFLICTS WITH EXISTING UTILITIES. COORDINATE RELOCATION WITH ENGINEER. NO ADDITIONAL PAYMENT WILL BE PROVIDED FOR DAMAGE TO EXISTING UTILITIES. CONTRACTOR IS RESPONSIBLE TO INCLUDE ALL WORK NECESSARY TO INSTALL THIS PIPE, INCLUDING TRANSPLANTING OR PLANTING NEW TREES IF NECESSARY.

#### INFILTRATION SYSTEM CONSTRUCTION NOTE

- WITHIN THE INFILTRATION SYSTEM, THE CONTRACTOR SHALL REMOVE ALL TOPSOIL AND SUBSOIL AREAS (A AND B HORIZONS) AND ANY EXISTING SOILS THAT YIELD A PERMEABILITY RATE <1.02 INCHES/HOUR. CONTRACTOR SHALL COORDINATE INSPECTIONS WITH OWNER, ENGINÉER, AND CONSERVATION AGENT DURING: EXCAVATION FOR INFILTRATION UNITS PRIOR TO PLACEMENT OF STONE, AND AFTER CHAMBERS (AND FILTER FABRIC) HAVE BEEN INSTALLED PRIOR TO BACKFILLING. IF NECESSARY THE AREA SHALL BÉ PREPARED WITH SAND FILL SOIL MEETING THE MEDIA REQUIREMENTS OF SAND FILTERS, AS DESCRIBED IN THE MASSACHUSETTS STORMWATER HANDBOOK AND DESIGN STANDARDS, LATEST EDITION. THE DEPTH OF EXISTING SOIL REMOVAL SHALL BE VERIFIED BY THE ENGINEER. PLACEMENT OF THE SAND FILL (ASTM C-33 SAND), SHALL BE USED TO BRING THE BOTTOM OF BASIN TO THE DESIGN ELEVATIONS.
- 2. INFILTRATION SYSTEM CONSTRUCTION AND MATERIALS SHALL CONFORM TO MASSACHUSETTS STORMWATER HANDBOOK AND DESIGN STANDARDS, LATEST EDITIONAFTER CONSTRUCTION, THE CONTRACTOR SHALL COORDINATE FINAL INSPECTIONS WITH THE
- 3. THE CONTRACTOR IS REQUIRED TO SUBMIT A LIST OF MATERIALS, GRADATIONS AND THE NAME AND ADDRESS OF THE SUPPLIERS TO THE ENGINEER FOR APPROVAL PRIOR TO BRINGING MATERIAL ON SITE. MATERIAL CERTIFICATIONS SHALL ALSO BE REQUIRED FOR REVIEW AND APPROVAL
- 4. THE CONTRACTOR IS RESPONSIBLE TO BECOME FAMILIAR WITH THE ABOVE REFERENCED MANUAL. THE MANUAL CAN BE FOUND AT: https://www.mass.gov/guides/massachusetts-stormwater-handbook-andstormwater-standards
- 5. GREAT CARE MUST BE TAKEN TO PREVENT THE INFILTRATION AREA FROM COMPACTION: BY MARKING OFF THE INFILTRATION UNDERGROUND SYSTEM LOCATION BEFORE THE START OF CONSTRUCTION, AND BY CONNECTING UPSTREAM DRAINAGE AREAS ONLY AFTER CONSTRUCTION IS COMPLETE AND THE CONTRIBUTING AREA IS STABILIZED.
- 6. IF LARGE ROCKS OR BOULDERS ARE FOUND WITHIN 36" BELOW THE INFILTRATION SYSTEMS, OR WITHIN A 10' PERIMETER AROUND SYSTEM, THE CONTRACTOR SHALL REMOVE THE ROCKS/BOULDERS AND REPLACE WILL GRAVEL BORROW. CONTRACTOR SHALL COORDINATE WITH ENGINEER.
- 6. THE CONTRACTOR MUST SUBMIT SHOP DRAWINGS FOR THE PIPES TO BE USED IN THE UNDERGROUND INFILTRATION SYSTEMS TO THE ENGINEER PRIOR TO CONSTRUCTION. THE SHOP DRAWINGS MUST VERIFY THAT THE PIPES CAN SUPPORT H-20 LOADING WITH THE SYSTEM SPECIFIC COVER.
- 7. UNDERGROUND INFILTRATION SYSTEMS SHALL BE INSTALLED PER MANUFACTURER SPECIFICATIONS AND INSTALLATION INSTRUCTIONS.

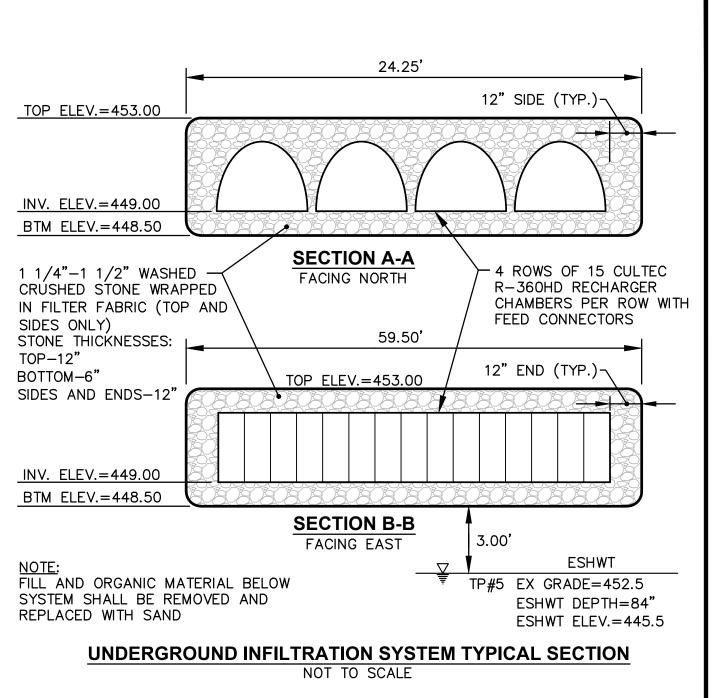

33.67

112.00

**SECTION A-A** 

FACING NORTH

TOP ELEV.=454.50

**SECTION B-B** 

FACING EAST

**UNDERGROUND DETENTION SYSTEM TYPICAL SECTION** 

NOT TO SCALE

TOP ELEV.=454.50

INV. ELEV.=449.50

SIDES ONLY)

TOP-6"

BOTTOM-6"

BTM ELEV.=449.00

STONE THICKNESSES:

INV. ELEV.=449.50

BTM ELEV.=449.00

48" DIA. MANIFOLD —

1 1/4"-1 1/2" WASHED -

CRÚSHED STONE WRAPPED

IN FILTER FABRIC (TOP AND

18" SIDE (TYP.)¬

5 ROWS x 5 (20 LF


SEGMENTS) CHAMBERS

PER ROW OF 48" ADS

N-12 SOLID PIPE WITH

18" END (TYP.)¬

MANIFOLDS AT EACH END

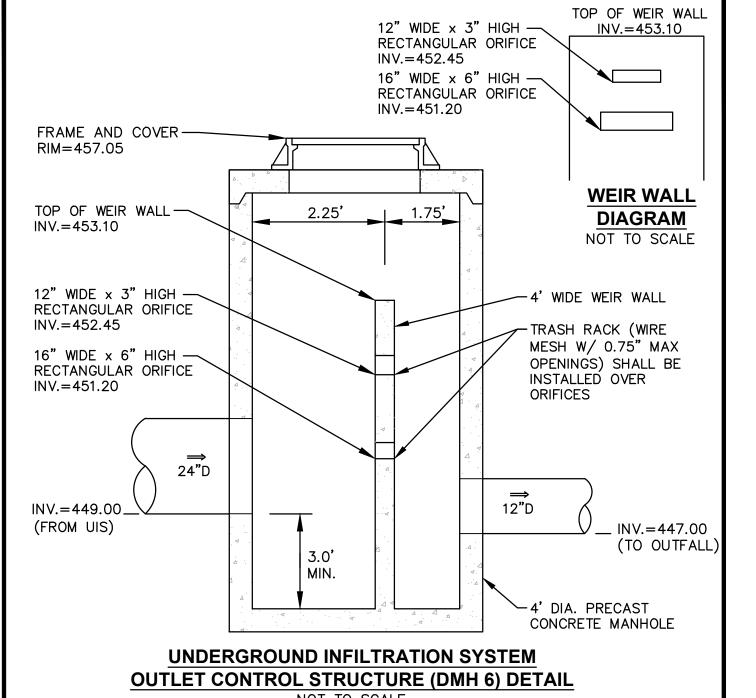

NOT TO SCALE

UNDERGROUND DETENTION SYSTEM

**OUTLET CONTROL STRUCTURE (DMH 5) DETAIL** 

NOT TO SCALE

FRAME AND COVER-


RIM = 456.90

INV. = 453.40

INV.=449.50

INV.=449.50\_

(FROM UDS)

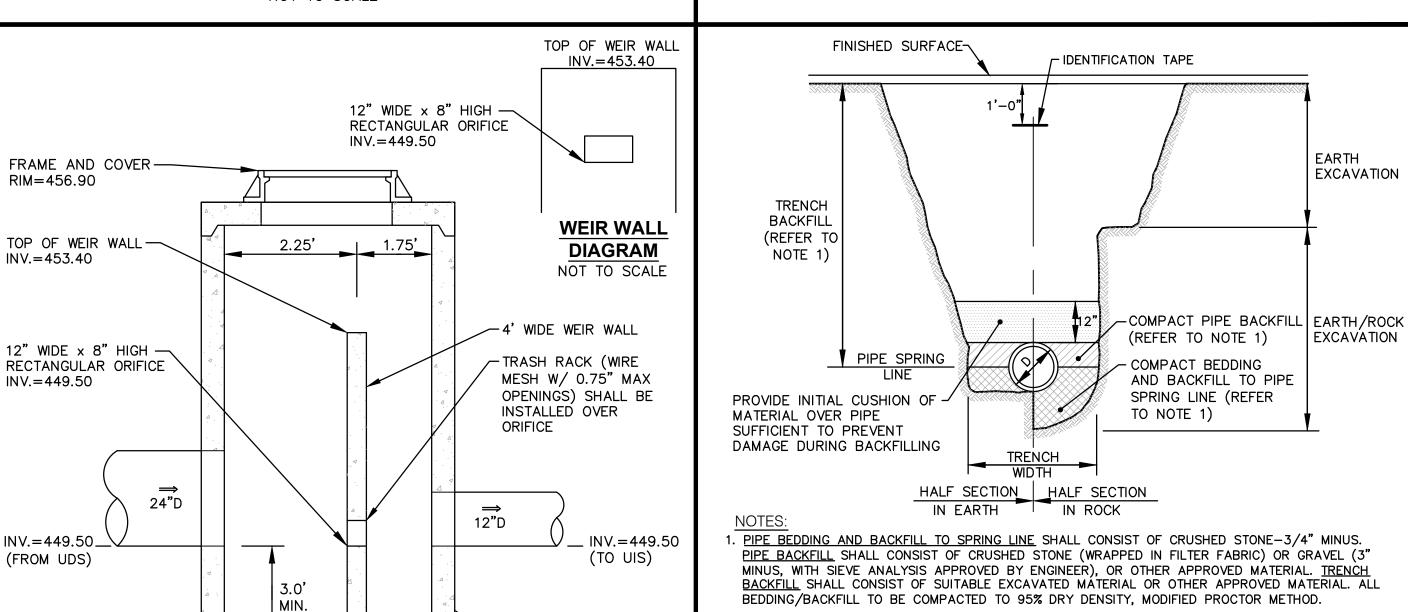

DIA. PRECAST

NOT TO SCALE

CONCRETE MANHOLE

. <u>PIPE BEDDING AND BACKFILL TO SPRING LINE</u> SHALL CONSIST OF CRUSHED STONE-3/4" MINUS. PIPE BACKFILL SHALL CONSIST OF CRUSHED STONE (WRAPPED IN FILTER FABRIC) OR GRAVEL (3" MINUS. WITH SIEVE ANALYSIS APPROVED BY ENGINEER), OR OTHER APPROVED MATERIAL. TRENCH BACKFILL SHALL CONSIST OF SUITABLE EXCAVATED MATERIAL OR OTHER APPROVED MATERIAL. ALL BEDDING/BACKFILL TO BE COMPACTED TO 95% DRY DENSITY, MODIFIED PROCTOR METHOD.

CULTEC 12" x 6" Inspection Port Kit

- 24.0° [610 mm] MIN. -

-| 15.0° [381 mm] |-

AASHTO HS-25 RATED CAS

CONNECT ONTO CLEAN-OUT

6" [150mm] PVC SCREW IN CAP

IRON FRAME AND SOLID COVER

SCREWED ON INSIDE CLEAN-OU

12" [300mm] X 6" [150mm] CULTEC

INLINE DRAIN / CLEAN-OUT BASIN W/ GASKETED SDR-35 CONNECTION

CONNECT ONTO 6" SDR-35 RISER

6" [150mm] SDR-35 RISER (CUT TO LENGTH) INSERTED INTO 6" [150mm] SDR-35 BELL END —

PART NOT PROVIDED BY CULTEC

CUT FOR 6" [152mm] OF INSERTED PIPE -

PART NOT PROVIDED BY CULTEC

6" [150mm] SDR-35 BELL END

UNDERGROUND INFILTRATION SYSTEM INSPECTION PORT DETAIL

NOT TO SCALE

8.0° MIN. [203 mm]

5.0° [152 mm] MIN.

FIELD PLACED CLASS "C" CONCRETE COLLAR (OPTION 1) FLUSH WITH PAVEMENT

12" [300mm] X 6" [150mm] CULTEC INLINE DRAIN / CLEAN-OUT BASIN w/ GASKETED SDR-35 CONNECTION

AASHTO HS-25 RATED CAST IRON

FIELD PLACED CLASS \*C" CONCRETE
- COLLAR (OPTION 2) 1.50\* [40mm] BELOW

FRAME AND SOLID COVER

PAVEMENT OR FINISHED GRADE

6" [150mm] PVC SCREW IN CAP

6" [150mm] SDR-35 RISER (LENGTH VARIES)


6.25" [160mm] HOLE TO BE CUT w/ HOLE SAW


6\* [150mm] SDR-35 BELL END

2. ALL TRENCH EXCAVATION AND ANY SHEETING AND SHORING SHALL BE DONE IN ACCORDANCE WITH ALL STATE AND LOCAL CODES AND OSHA REGULATIONS.

3. MINIMUM TRENCH WIDTH SHALL BE OUTSIDE DIAMETER OF PIPE AT BELL PLUS 12". MAXIMUM TRENCH WIDTH SHALL BE OUTSIDE DIAMETER OF PIPE AT BELL PLUS 24".

TRENCH DETAIL NOT TO SCALE

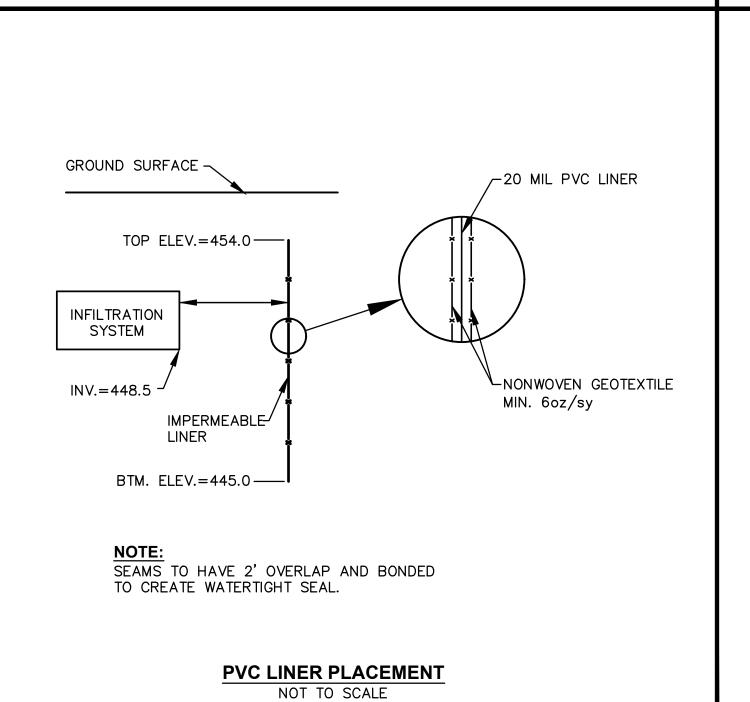

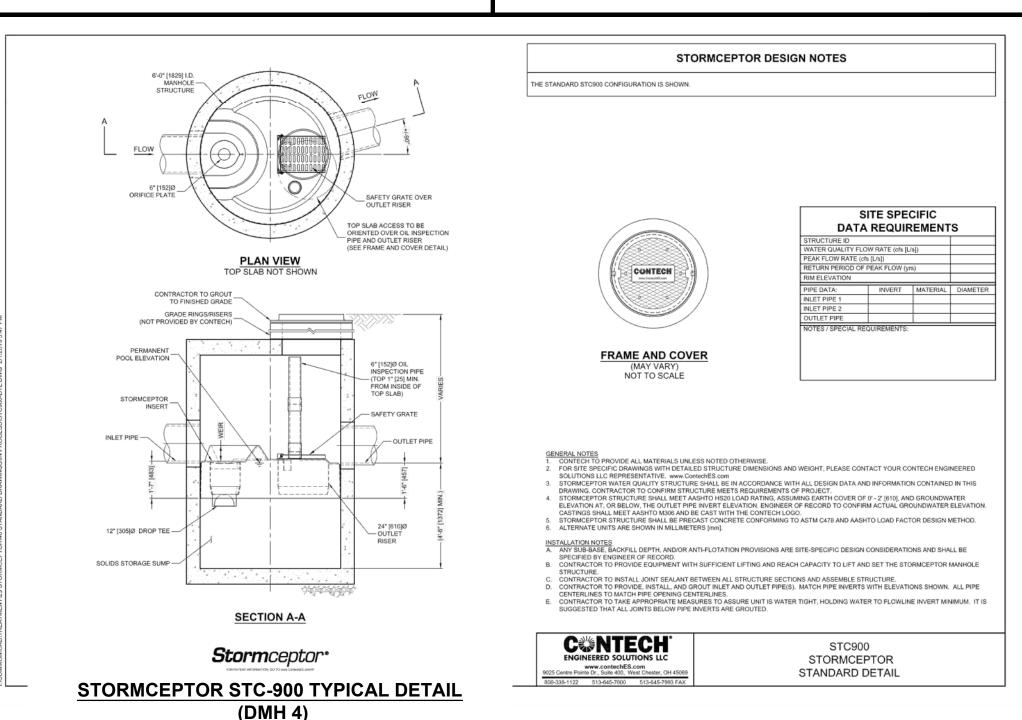



 Environmental Site Planning Surveying Permitting Landscape Architecture

**Crossman Engineering** 

Phone (401) 738-5660

Warwick, RI 02886 North Attleboro, MA 02763 Phone (508) 695-1700

Email: cei@crossmaneng.com

THESE DRAWINGS ARE THE PROPERTY OF CROSSMAN NGINEERING AND HAVE BEEN PREPARED FOR THEIR CLIEN FOR A SPECIFIC SITE AND PROJECT. THESE DRAWINGS AF NOT TO BE COPIED OR USED FOR ANY OTHER PURPOSE WITHOUT THE WRITTEN CONSENT OF CROSSMAN ENGINEERIN

KEY PLAN

PROJECT TITLE:

**EXCAVATION** 

PROPOSED CAR WASH PLAT MAP 38, BLOCK 35 LOT 2 **ZONING DISTRICTS: BL-1.0 and RL-7 BUSINESS LIMITED and** SINGLE FAMILY DISTRICT 1059 GRAFTON STREET

**WORCESTER, MA** 

PREPARED FOR:

1059 GRAFTON STREET, LLC C/O BASS, DOHERTY & FINKS, P.C. 1380 SOLDIERS FIELD ROAD **BOSTON, MA 02135-1023** 

DRAWING TITLE:

JUNE 2023

**MISCELLANEOUS DETAIL PLAN No. 3** 

AS SHOWN


DWG. NAME:		
М	280-C11-DETAIL3-	R3.dwg
REVISIONS		
$\triangle$		
NUMBER	REMARKS	DATE
1	PLANNING BOARD COMMENTS	08/01/23
2	CITY COMMENTS	08/18/23
3	SEWER CONNECTION	01/25/24

DRAWING NUMBER

SHEET: 12 OF: 21

#### **WATER NOTES**

- 1. ALL INSTALLATION, JOINTS, CONSTRUCTION METHODS AND MATERIALS SHALL CONFORM TO THE CURRENT RULES AND REGULATIONS OF THE AWWA STANDARDS, DEP GUIDELINES, CITY OF WORCESTER - DEPARTMENT OF PUBLIC WORKS AND PARKS - STANDARD CONSTRUCTION SPECIFICATIONS AND DETAILS.
- 2. CONSTRUCTION SHALL INCLUDE ALL PIPE, JOINTS, BENDS, TEES, FITTINGS, THRUST BLOCKS, GATE VALVES, GATE BOXES, SERVICE CONNECTIONS AND ALL MISCELLANEOUS ITEMS REQUIRED TO CONSTRUCT THE PROPOSED SYSTEM.
- 3. CONCRETE THRUST, ANCHOR, OR BEARING BLOCKS SHALL BE INSTALLED IN LOCATIONS INDICATED AND AT ALL BENDS, FITTINGS, PLUGS, ETC. WHEN A THRUST BLOCK CANNOT BE PLACED AGAINST UNDISTURBED EARTH, A MECHANICAL RESTRAINED JOINT PIPE MAY BE UTILIZED.
- 4. PRESSURE AND LEAKAGE TESTS AND DISINFECTING PIPES SHALL BE PERFORMED BY THE CONTRACTOR IN CONFORMANCE TO LOCAL WATER DEPARTMENT REQUIREMENTS, AMERICAN WATER WORKS ASSOCIATION (AWWA) RECOMMENDATIONS, AND GOVERNMENTAL AGENCIES HAVING JURISDICTION.
- 5. ALL GATE VALVES, FITTINGS, PIPE, JOINTS, ETC. SHALL BE DESIGNED FOR 1.5 TIMES WORKING PRESSURE BUT NOT LESS THAN 250 PSI.
- 6. WATER PIPE SHALL BE LOCATED AT A DEPTH OF COVER EQUAL TO 5' MINIMUM. A MINIMUM OF 10-FEET HORIZONTAL OR 18-INCH VERTICAL SEPARATION SHALL BE MAINTAINED IN THE PLACEMENT OF WATER MAINS, SERVICES, OR APPURTENANCES WITHIN THE VICINITY OF SEWER FACILITIES, OR VICE VERSA. WHERE THE ABOVE SEPARATION DISTANCES CANNOT BE ACHIEVED, THE SANITARY SEWER PIPE SHALL BE ENCASED WITHIN A DUCTILE IRON CARRIER PIPE FOR A DISTANCE EQUAL TO 10-FEET ON EITHER SIDE OF THE AREA OF CONCERN. CONCRETE ENCASEMENT IS NOT ALLOWED.
- 7. ALL SYSTEM COMPONENTS AND CONSTRUCTION METHODS, SUCH AS GATE VALVE, PIPE, THRUST BLOCKS, FITTINGS, CASTINGS, ETC. SHALL BE SUBMITTED TO THE LOCAL WATER AUTHORITY AND ENGINEER FOR APPROVAL PRIOR TO PURCHASE AND INSTALLATION. THIS SUBMISSION SHALL INCLUDE MANUFACTURER'S LITERATURE, SHOP DRAWINGS, PROPOSED CONSTRUCTION METHODS, ETC.
- 8. THE FINAL LOCATIONS FOR ALL INTERIOR PIPING, BACK FLOW PREVENTORS AND VALVES SHALL BE VERIFIED WITH THE PLUMBING AND FIRE SPRINKLER SYSTEM SUB-CONTRACTORS.
- 9. THE MANUFACTURER AND MODEL OF BACK FLOW PREVENTORS ARE TO BE VERIFIED BY THE APPROPRIATE PLUMBING AND FIRE SPRINKLER SUB-CONTRACTORS; AND MUST BE APPROVED FOR USE BY THE LOCAL WATER AUTHORITY PRIOR TO ORDERING.
- 10. AS-BUILT DRAWINGS MUST BE FURNISHED BY THE CONTRACTOR TO, AND APPROVED BY, THE LOCAL WATER AUTHORITY PRIOR TO WATER SERVICE ACTIVATION.
- 11. THE CONTRACTOR SHALL FURNISH AND INSTALL SUITABLE TEMPORARY TESTING PLUGS, CAPS, PUMPS, PIPE CONNECTIONS, AND OTHER APPURTENANCES, AS NECESSARY, TO OBTAIN SAMPLES.

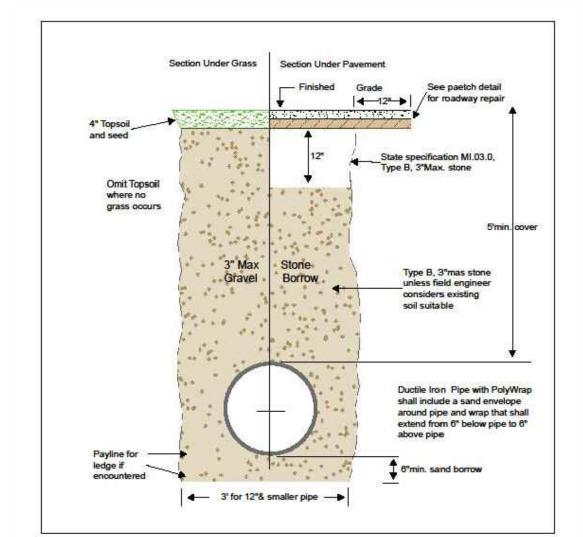

	Trench Detail	Rev. No.	Ву	Date
	Typical	1	M.F.J	1/24/79
City of Worcester DPW&P Water Operations	2	A.V.C.	4/13/93	
	3	A.C.M.	4/1/05	
	Drawn B	y: R.H.	5000000	
	Checked By: M.E.D.		Detail W-5	
	Last updat	e 2/3/2020		

#### to finish grade. Box box os Migd. by Tyler water 11/4",11/2" or 2" Type K Coppe meter volve Ball Yalve Curb Stop To be located near property line. Meter and male instolled by Cit

#### **GENERAL NOTES**

- Fittings and valves shall be manufactured by Ford or approved equal. Corporation: Ford FB1000 with tee head adapter (cc thread x comp.). Ball valve curb stop: Ford 844 series full port (comp. x
- A. Mains 16 inches in diameter and larger: Taps shall be by direct means only. Mains smaller than 16 inches in diameter: Service saddles shall be used. Saddles shall be
- double strap equal to Rockwell 313. Sand shall be used for backfilling from a point 6 inches below the pipe to a point 12 inches above the pipe. The remaining backfill shall have no stones greater than 3 inches in their largest dimension. Before any excavation is done and any pipe is installed, permits shall be obtained from the Management Services office at 20 East Worcester St. and the Water Engineering office at 18 East Worcester St. All paving shall conform to City of Worcester D.P.W. standards.
- Services shall be flushed before activating to avoid meter clogging. Main valves are to be operated by the City only. Costs incurred in shutting down mains due to
- negligence of the Contractor, as determined by the Field Inspector, shall be paid by the Contractor. The Contractor shall inform the owner and the City wire inspector of proper grounding requirements
- pursuant to M.G.L. Chapter 165, Section 1C. On new services, in accordance with the Mass. Department of Environmental Protection Code 5
- and its amendments, the water service shall be a minimum of 10 horizontal feet from the sewer 8. The Contractor shall furnish and completely install the service from corporation to the meter valves
- with new materials. Upon installation of the service box, the Contractor shall operate the valve to the satisfaction of the Field Inspector prior to acceptance of the job.


#### S:\WATER\STANDARD\General Notes for 2 inch service.doc

6" MIN

\_\_\_ SF \_\_\_ SF \_\_\_ SF \_\_

WATER SERVICE DETAIL	Rev. no.	by	date
TYPICAL 2 INCH,	Lake Auril 1	ACM	6/16/88
1 1/2 INCH or 1 1/4 INCH	2	AVC	2/12/92
CITY of WORCESTER	3	AVC	4/1/97
D. P. W.	drawn by:	mjf	DETAIL
WATER OPERATIONS	checked by:	ocm	W-88
and the same of		0.407	7 " "

(RECOMMENDED) WOODEN FENCE POST WITH 10' MAX

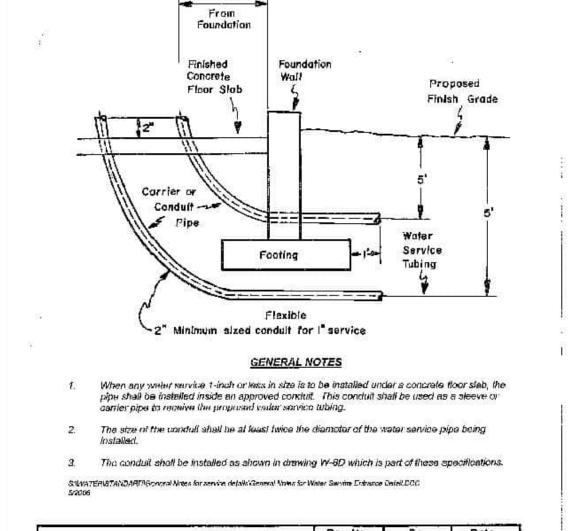

2 Minimum

Rev, No.	Ву	Date
		701-00-
- W-W-15		
Drawn By: F	N.8.	DETAIL
Checked By:	A.C.M.	W-80
	Orawn Sy: F	Province By P. N.B. Checked By: A.C.M.

5/12/06

SILT FENCE INSTALLATION NOTES

1. SILT FENCE MUST BE PLACED AWAY FROM THE TOE OF THE SLOPE TO ALLOW FOR WATER PONDING. SILT FENCE AT THE TOE OF A SLOPE SHOULD BE INSTALLED IN A FLAT LOCATION AT LEAST SEVERAL FEET (2-5 FT) FROM THE TOE OF THE SLOPE TO ALLOW ROOM FOR PONDING AND DEPOSITION.

2. A UNIFORM 6" X 4" ANCHOR TRENCH SHALL BE EXCAVATED USING TRENCHER OR SILT FENCE INSTALLATION DEVICE. NO ROAD GRADERS, BACKHOES, OR SIMILAR EQUIPMENT SHALL

3. COMPACT ANCHOR TRENCH BY HAND WITH A "JUMPING JACK" OR BY WHEEL ROLLING. COMPACTION SHALL BE SUCH THAT SILT FENCE RESISTS BEING PULLED OUT OF ANCHOR

4. SILT FENCE SHALL BE PULLED TIGHT AS IT IS ANCHORED TO THE STAKES. THERE SHOULD BE NO NOTICEABLE SAG BETWEEN STAKES AFTER IT HAS BEEN ANCHORED TO THE STAKES. 5. SILT FENCE FABRIC SHALL BE ANCHORED TO THE STAKES USING 1" HEAVY DUTY STAPLES OR NAILS WITH 1" HEADS. STAPLES AND NAILS SHOULD BE PLACED 3" ALONG THE FABRIC DOWN THE STAKE.

6. AT THE END OF A RUN OF SILT FENCE ALONG A CONTOUR, THE SILT FENCE SHOULD BE TURNED PERPENDICULAR TO THE CONTOUR TO CREATE A "J-HOOK." THE "J-HOOK" EXTENDING PERPENDICULAR TO THE CONTOUR SHOULD BE OF SUFFICIENT LENGTH TO KEEP RUNOFF FROM FLOWING AROUND THE END OF THE SILT FENCE (TYPICALLY 10' - 20').

7. SILT FENCE SHALL BE INSTALLED PRIOR TO ANY LAND DISTURBING ACTIVITIES.

SILT FENCE MAINTENANCE NOTES 1. INSPECT BMPs EACH WORKDAY, AND MAINTAIN THEM IN EFFECTIVE OPERATING CONDITION. MAINTENANCE OF BMPs SHOULD BE PROACTIVE, NOT REACTIVE. INSPECT BMPs AS SOON AS POSSIBLE (AND ALWAYS WITHIN 24 HOURS) FOLLOWING A STORM THAT CAUSES SURFACE


2. FREQUENT OBSERVATIONS AND MAINTENANCE ARE NECESSARY TO MAINTAIN BMPs IN EFFECTIVE OPERATING CONDITION. INSPECTIONS AND CORRECTIVE MEASURES SHOULD BE

3. WHERE BMPs HAVE FAILED, REPAIR OR REPLACEMENT SHOULD BE INITIATED UPON DISCOVERY OF THE FAILURE.

4. SEDIMENT ACCUMULATED UPSTREAM OF THE SILT FENCE SHALL BE REMOVED AS NEEDED TO MAINTAIN THE FUNCTIONALITY OF THE BMP, TYPICALLY WHEN DEPTH OF ACCUMULATED SEDIMENTS IS APPROXIMATELY 6".

5. REPAIR OR REPLACE SILT FENCE WHEN THERE ARE SIGNS OF WEAR, SUCH AS SAGGING, TEARING, OR COLLAPSE. 6. SILT FENCE IS TO REMAIN IN PLACE UNTIL THE UPSTREAM DISTURBED AREA IS STABILIZED AND APPROVED BY THE LOCAL JURISDICTION, OR IS REPLACED BY AN EQUIVALENT PERIMETER SEDIMENT CONTROL BMP.


7. WHEN SILT FENCE IS REMOVED, ALL DISTURBED AREAS SHALL BE COVERED WITH TOPSOIL, SEEDED AND MULCHED OR OTHERWISE STABILIZED AS APPROVED BY LOCAL JURISDICTION.

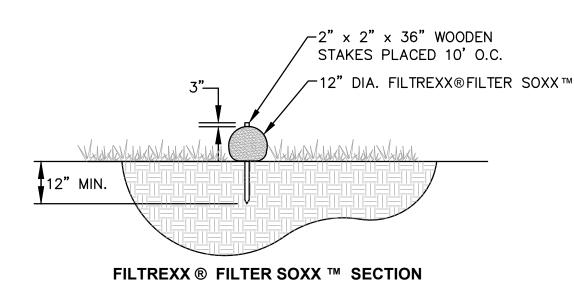

#### **NOTES**


- 1 CONTRACTOR IS RESPONSIBLE TO BECOME FAMILIAR WITH THE FILTREXX PRODUCTS AND COORDINATE INSTALLATION SCHEDULES AND METHODS WITH THE ENGINEER PRIOR TO PLACEMENT.
- 2. ALL MATERIAL SHALL MEET FILTREXX SPECIFICATIONS.
- 3. COMPOST MATERIAL TO BE DISPERSED ON SITE AS DETERMINED BY ENGINEER.


FILTREXX ® FILTER SOXX ™ DETAIL NOT TO SCALE

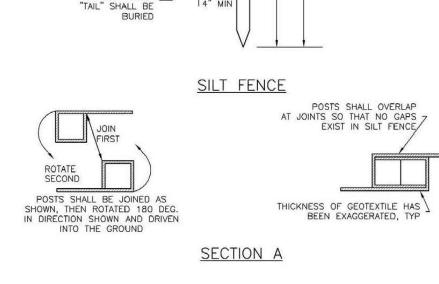

#### SILTL FENCE DETAIL NOT TO SCALE



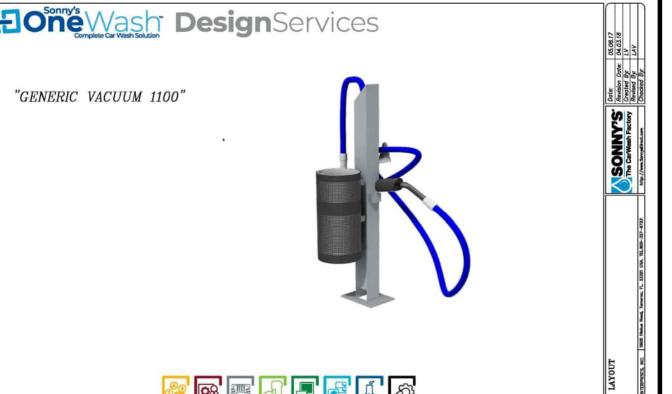


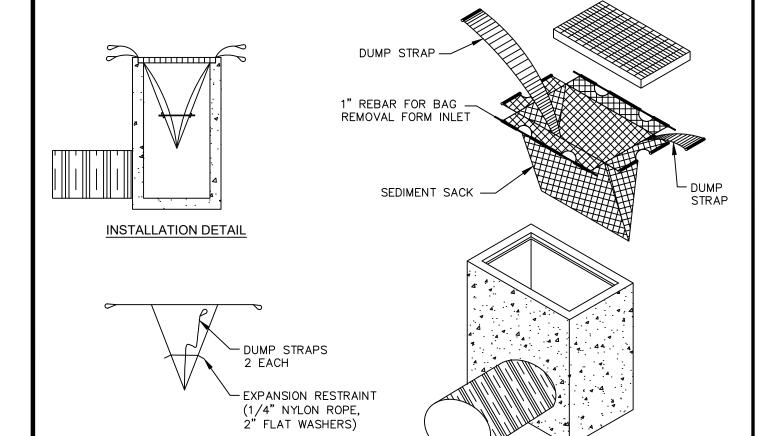


**BAG DETAIL** 

- 1. INSTALL SILT SACK AT CATCH BASINS IN VICINITY OF CONSTRUCTION.
- 2. CONTRACTOR SHALL SUBMIT SILT SACK PRODUCT TO ENGINEER FOR APPROVAL.

TYPICAL SILT SACK DETAIL NOT TO SCALE

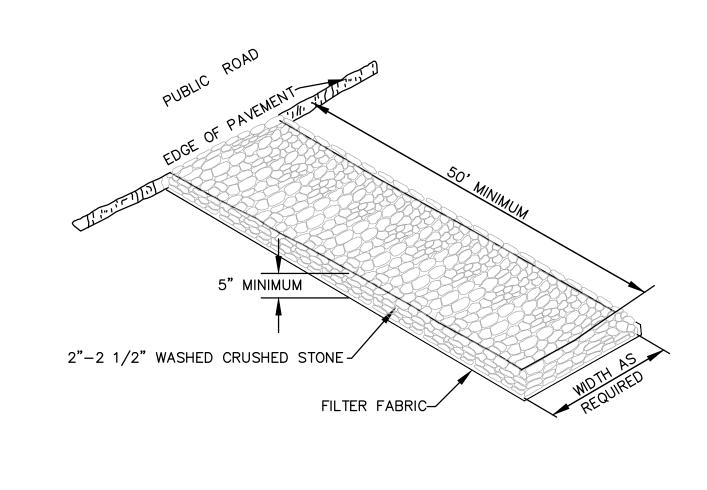

TEMPORARY CONSTRUCTION ENTRANCE DETAIL NOT TO SCALE

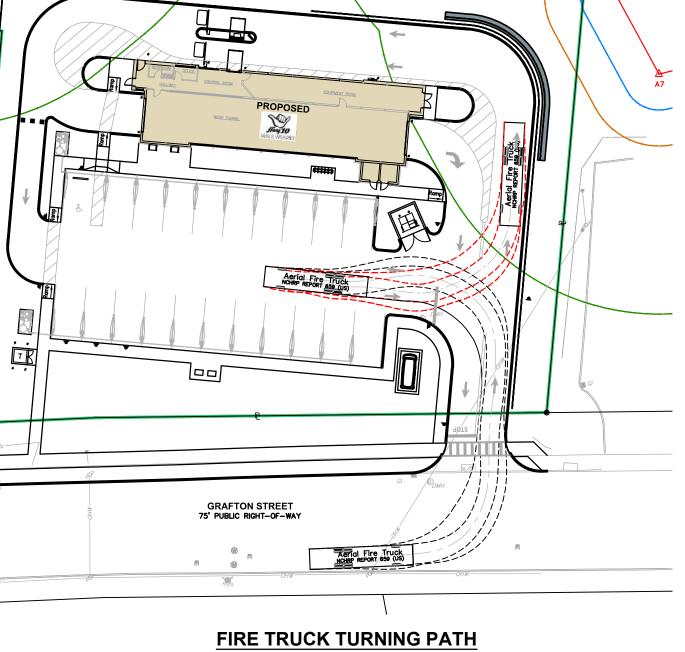

SCALE: 1"'40'

Sheet Rev. 4.00 -0-

DRAWING NUMBER

Civil

**Crossman Engineering** 

151 Centerville Road 103 Commonwealth Avenue

Warwick, RI 02886 North Attleboro, MA 02763

Email: cei@crossmaneng.com

THESE DRAWINGS ARE THE PROPERTY OF CROSSMAN

ENGINEERING AND HAVE BEEN PREPARED FOR THEIR CLIENT

FOR A SPECIFIC SITE AND PROJECT. THESE DRAWINGS AR

NOT TO BE COPIED OR USED FOR ANY OTHER PURPOSE

WITHOUT THE WRITTEN CONSENT OF CROSSMAN ENGINEERING

KEY PLAN

PROJECT TITLE:

PREPARED FOR:

DRAWING TITLE:

JUNE 2023

DWG. NAME:

REVISIONS

NUMBER

PROPOSED CAR WASH

PLAT MAP 38,

**BLOCK 35 LOT 2** 

**ZONING DISTRICTS: BL-1.0 and RL-7** 

**BUSINESS LIMITED and** 

SINGLE FAMILY DISTRICT

1059 GRAFTON STREET

WORCESTER, MA

1059 GRAFTON STREET, LLC

C/O BASS, DOHERTY & FINKS, P.C.

**1380 SOLDIERS FIELD ROAD BOSTON, MA 02135-1023** 

**MISCELLANEOUS** 

**DETAIL PLAN No. 4** 

REMARKS

CITY COMMENTS

SEWER CONNECTION

M280-C12-DETAIL4-R3.dwg

PLANNING BOARD COMMENTS 08/01/23

AS SHOWN

DATE

08/18/23

01/25/24

Phone (401) 738-5660 Phone (508) 695-1700

 Transportation Environmental

Site Planning

Landscape Architecture

Surveying

Permitting

#### **GENERAL SEWER NOTES**


- 1. INSTALLATION OF THE SEWERAGE FACILITIES SHALL BE IN ACCORDANCE WITH THE CITY OF WORCESTER DEPARTMENT OF PUBLIC WORKS AND PARKS SPECIFICATIONS AND REQUIREMENTS.
- 2. ALL SEWERAGE FACILITIES SHALL MEET TESTING AND CLEANING REQUIREMENTS PRIOR TO
- 3. THE CONTRACTOR IS RESPONSIBLE TO COORDINATE AS-BUILT LOCATIONS PRIOR TO PIPE BACKFILL. AS-BUILT DRAWINGS SHALL BE FURNISHED AS A CONDITION FOR ACCEPTANCE OF THE NEW SEWERAGE FACILITIES. PLANS SHALL INCLUDE LOCATION OF WYES.
- 4. NO FLOW WILL BE ACCEPTED UNTIL ALL ABOVE STEPS ARE COMPLETED AND COMPLETION CERTIFICATE IS ISSUED.
- 5. AFTER THE CONTRACTOR HAS "STAKED OUT" THE FACILITIES TO BE CONSTRUCTED AND HAS THE APPROVED MATERIALS ON THE JOB, NBC SHALL BE NOTIFIED IN ADVANCE OF CONSTRUCTION IN ORDER FOR THEM TO ARRANGE FOR THEIR INSPECTOR. THE NOTIFICATION MUST MEET WORCESTER
- 6. ALL CONSTRUCTION SHALL BE IN ACCORDANCE WITH THE APPROVED PLANS AND MATERIALS. STANDARDS AND SPECIAL DETAILS, AND STANDARD SPECIFICATIONS, ANY WORK NOT MEETING THE APPROVED STANDARDS SHALL BE IMMEDIATELY REMOVED AND REPLACED AT THE CONTRACTOR'S
- 7. THE CONTRACTOR SHALL CONFINE HIS OPERATIONS AND ACTIVITIES FOR CONSTRUCTION WITHIN THE LIMITS OF WORK AS SHOWN ON THE DRAWINGS.
- 8. ALL AREAS DISTURBED BY THE CONTRACTOR SHALL BE RESTORED TO THEIR ORIGINAL CONDITION AT NO EXTRA COST TO THE OWNER. ALL GRASSED AREAS DISTURBED BY THE CONTRACTOR'S OPERATIONS SHALL BE LOAMED AND SEEDED.
- 9. LOCATION AND DEPTHS OF EXISTING UTILITIES ARE APPROXIMATE AND HAVE BEEN PLOTTED FROM THE BEST AVAILABLE INFORMATION. THE CONTRACTOR SHALL VERIFY LOCATIONS OF ALL EXISTING UTILITIES AND NOTIFY THE APPROPRIATE UTILITY AUTHORITIES INCLUDING "DIG-SAFE" PRIOR TO STARTING WORK. ANY DAMAGE TO UTILITIES CAUSED BY THE CONTRACTOR'S OPERATIONS SHALL BE THE RESPONSIBILITY OF THE CONTRACTOR AND THE COST OF REPAIRS SHALL BE BORNE BY THE CONTRACTOR AT NO ADDITIONAL COST TO THE OWNER.


#### 11. RELATION TO WATER LINES:


- A. HORIZONTAL SEPARATION: WHENEVER POSSIBLE, SEWERS SHOULD BE LAID AT A MINIMUM OF 10 FEET (3.0 m), HORIZONTALLY, FROM ANY EXISTING OR PROPOSED WATER LINE. SHOULD LOCAL CONDITIONS PREVENT A LATERAL SEPARATION OF 10 FEET, A SEWER MAY BE LAID CLOSER THAN 10 FEET TO A WATER LINE IF:
- 1. IT IS LAID IN A SEPARATE TRENCH, OR IF
- 2. IT IS LAID IN THE SAME TRENCH WITH THE WATER LINE LOCATED AT ONE SIDE ON A BENCH OF UNDISTURBED EARTH, AND IF
- 3. IN EITHER CASE THE ELEVATION OF THE TOP (CROWN) OF THE SEWER IS AT LEAST 18 INCHES (46 cm) BELOW THE BOTTOM (INVERT) OF THE WATER LINE.
- VERTICAL SEPARATION: WHENEVER A SEWER MUST CROSS UNDER WATER LINES, THE SEWER SHALL BE LAID AT SUCH AN ELEVATION THAT THE TOP OF THE SEWER IS AT LEAST 18 INCHES (46 cm) BELOW THE BOTTOM OF THE WATER LINE. WHEN THE ELEVATION OF THE SEWER CANNOT BE VARIED TO MEET THE ABOVE REQUIREMENTS, THE WATER LINE SHALL BE RELOCATED TO PROVIDE THIS SEPARATION OR RECONSTRUCTED WITH MECHANICAL—JOINT PIPE FOR A DISTANCE OF 10 FEET (3.0 m) ON EACH SIDE OF THE SEWER. ONE FULL LENGTH OF WATER LINE SHOULD BE CENTERED OVER THE SEWER SO THAT BOTH JOINTS WILL BE AS FAR FROM THE SEWER AS
- WHEN IT IS IMPOSSIBLE TO OBTAIN HORIZONTAL AND/OR VERTICAL SEPARATION AS STIPULATED ABOVE, BOTH THE WATER LINE AND SEWER SHALL BE CONSTRUCTED OF MECHANICAL-JOINT CEMENT LINED DUCTILE IRON PIPE OR OTHER EQUIVALENT BASED ON WATER TIGHTNESS AND STRUCTURAL SOUNDNESS. BOTH PIPES SHALL BE PRESSURE TESTED BY AN APPROVED METHOD TO ASSURE WATER TIGHTNESS.
- 12. CONTRACTOR SHALL BE RESPONSIBLE FOR ANY DEWATERING REQUIRED IN THE SEWER
- 13. THE PROPOSED GRAVITY SANITARY SEWER PIPE SHALL BE PVC ASTM 3034 SDR 35, UNLESS OTHERWISE SHOWN ON PLANS. PIPE SIZE TO MATCH UTILITY PLAN.
- 14. THE CONTRACTOR IS RESPONSIBLE TO VERIFY THE ELEVATION OF EXISTING SEWER LINE PRIOR TO INSTALLATION.

#### **SEWER TRENCH NOTES**

- MINIMUM WIDTH (W) OF TRENCH IS EQUAL TO THE INSIDE DIAMETER OF THE PIPE PLUS 12"
- 2. SOIL UNDER CRUSHED STONE FOUNDATION SHALL BE UNDISTURBED AND COMPACTED MATERIAL WITH SEVERAL PASSES OF A VIBRATORY PLATE COMPACTOR TO ATTAIN 95% MAX. DENSITY
- 3. CRUSHED STONE FOUNDATION 3/4" MAXIMUM SIZE, SHALL BE PLACED 6" UNDER THE PIPE AND UP TO THE PIPE LAID THÉREON, CRUSHED STONE PULLED AGAINST THE PIPE SIDES TO FIRMLY HOLD THE PIPE IN PLACE.
- 4. CRUSHED STONE HAUNCHING 3/4" MAXIMUM SIZE SHALL BE BROUGHT LEVEL TO THE TOP OF THE PIPE AND OUT TO THE TRENCH WALL AT THIS ELEVATION FOR ALL PIPE.

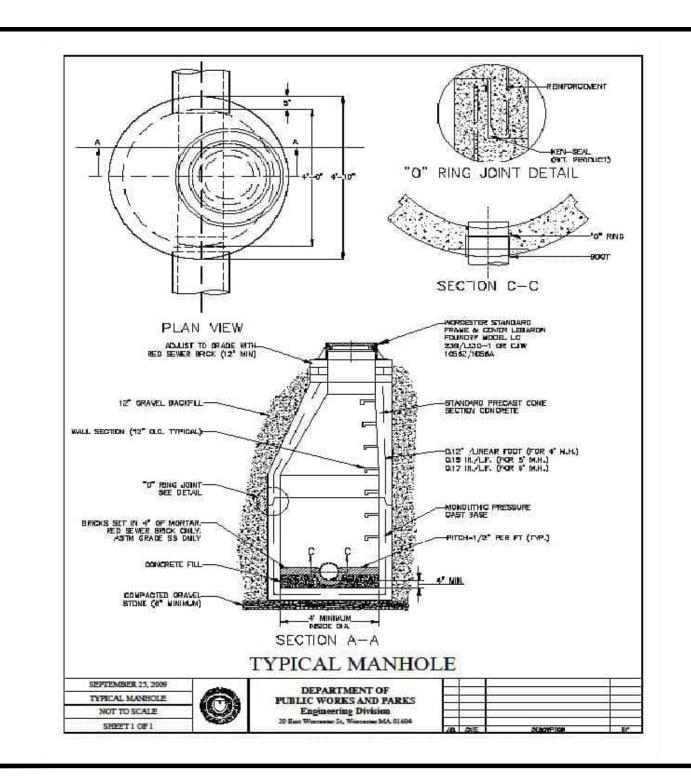

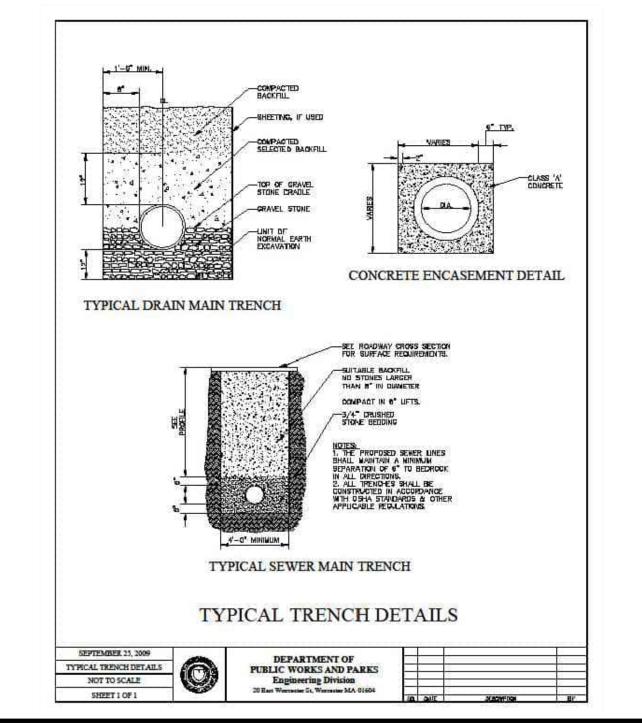

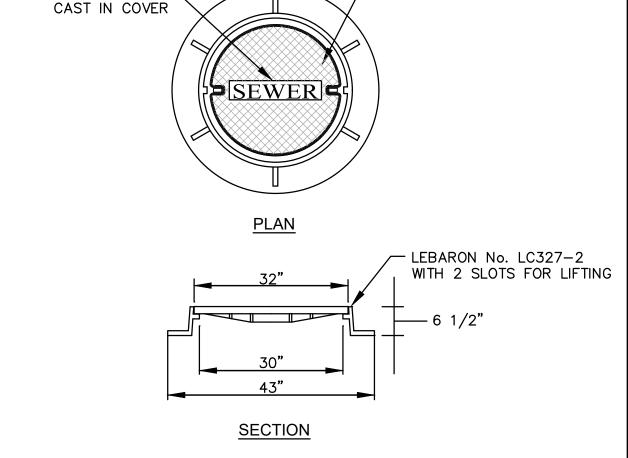

— DIAMOND DESIGN


# **NOTES**

1. FRAME AND COVER SEATS MUST HAVE MACHINE FINISH.


WORD "SEWER"


- 2. THE WORD "SEWER" SHALL BE CAST IN THE COVER.
- 3. VENTILATION HOLES OF ANY SIZE ARE NOT ALLOWED.

SANITARY MANHOLE FRAME AND COVER DETAIL NOT TO SCALE

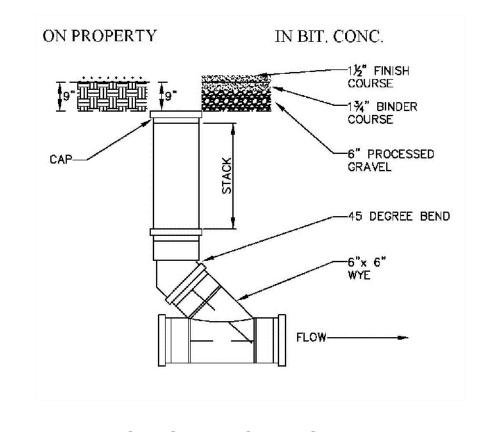



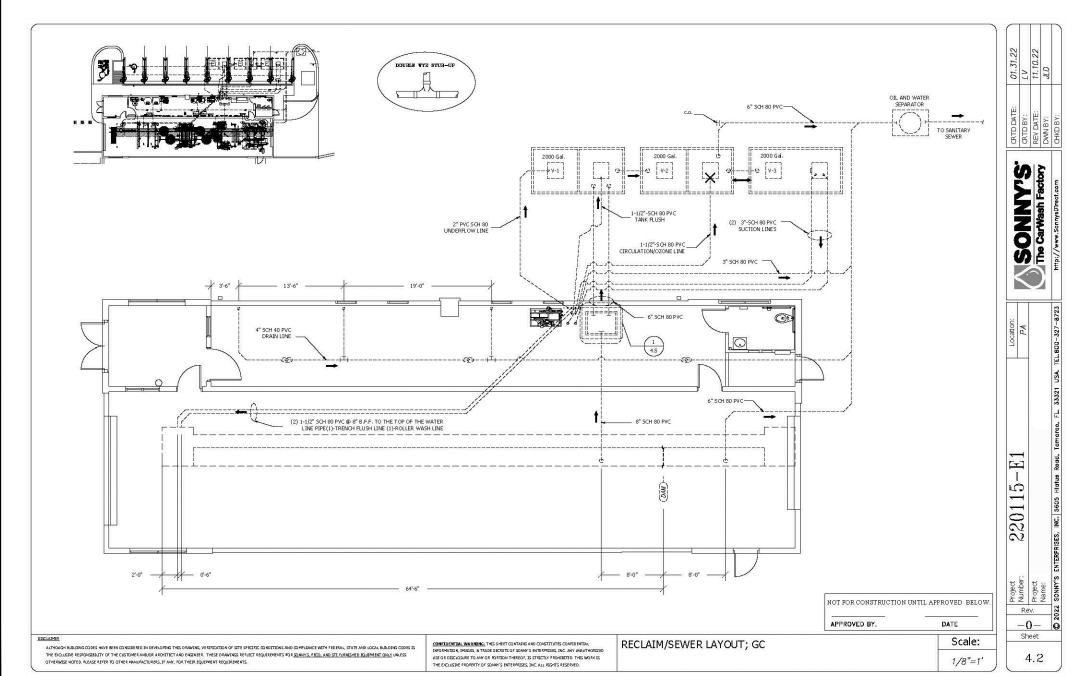

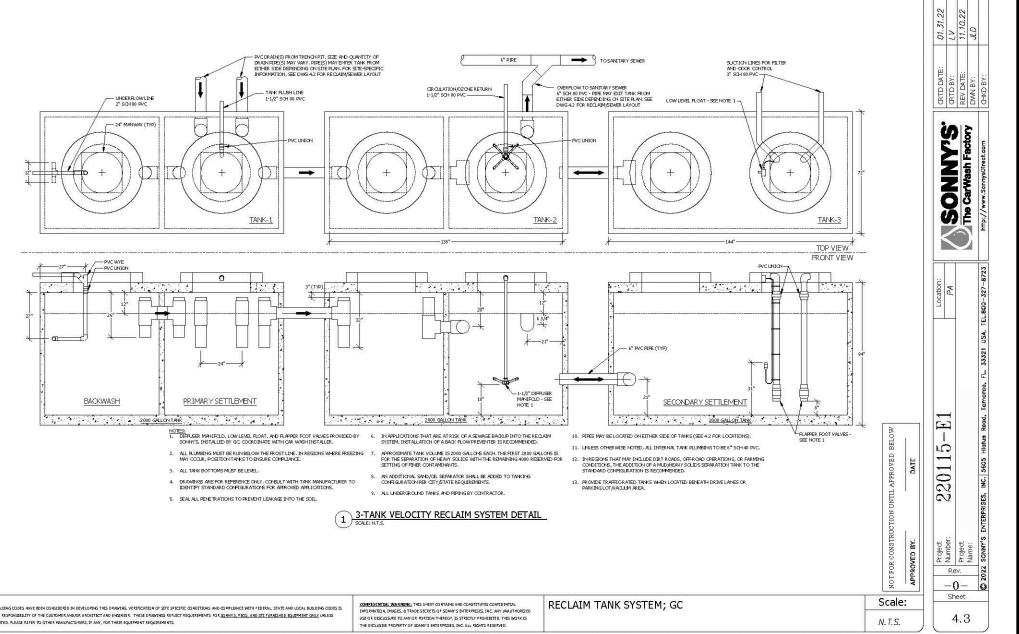

<u>General Notes:</u> Concrete Specifications: 1) 4000 psi @ 28 Days 2) 4%-6% Entrained Air Tank Penetrations Are Integrally Cast 4) All Joints Sealed With Butyl Rubber Joint Sealan ) Tanks Should be ?) Access Covers Should have Risers to Bring Cover Access to Grade Chamber Vent Information ) The required Chamber Vent shall be piped into the building per 248 CMR10.16.5(e) 2) The vent shall be of cast iron, and have a minimum diameter of 4 USE 1,500 GALLON GREASE TRAP.

**Worcester Standard 2 Compartment Grease Interceptor** 



Site Planning Surveying Permitting Landscape Architecture

 Transportation Environmental

Civil

# **Crossman Engineering**

151 Centerville Road 103 Commonwealth Avenue Warwick, RI 02886 North Attleboro, MA 02763 Phone (401) 738-5660 Phone (508) 695-1700

Email: cei@crossmaneng.com

THESE DRAWINGS ARE THE PROPERTY OF CROSSMAN ENGINEERING AND HAVE BEEN PREPARED FOR THEIR CLIENT FOR A SPECIFIC SITE AND PROJECT. THESE DRAWINGS ARE NOT TO BE COPIED OR USED FOR ANY OTHER PURPOSE WITHOUT THE WRITTEN CONSENT OF CROSSMAN ENGINEERING

KEY PLAN

PROJECT TITLE:

PROPOSED CAR WASH PLAT MAP 38, BLOCK 35 LOT 2 **ZONING DISTRICTS: BL-1.0 and RL-7 BUSINESS LIMITED and** SINGLE FAMILY DISTRICT 1059 GRAFTON STREET

**WORCESTER, MA** 

PREPARED FOR:

1059 GRAFTON STREET, LLC C/O BASS, DOHERTY & FINKS, P.C. 1380 SOLDIERS FIELD ROAD **BOSTON, MA 02135-1023** 

DRAWING TITLE:

JUNE 2023

# **MISCELLANEOUS DETAIL PLAN No. 5**


AS SHOWN

DWG. NAME: M280-C13-DETAIL5-R3.dwg REVISIONS NUMBERREMARKS DATEPLANNING BOARD COMMENTS 08/01/23 CITY COMMENTS 08/18/23 SEWER CONNECTION 01/25/24

DRAWING NUMBER

SHEET: 14 OF: 21

**RECLAIM TANK SYSTEM DETAIL** NOT TO SCALE

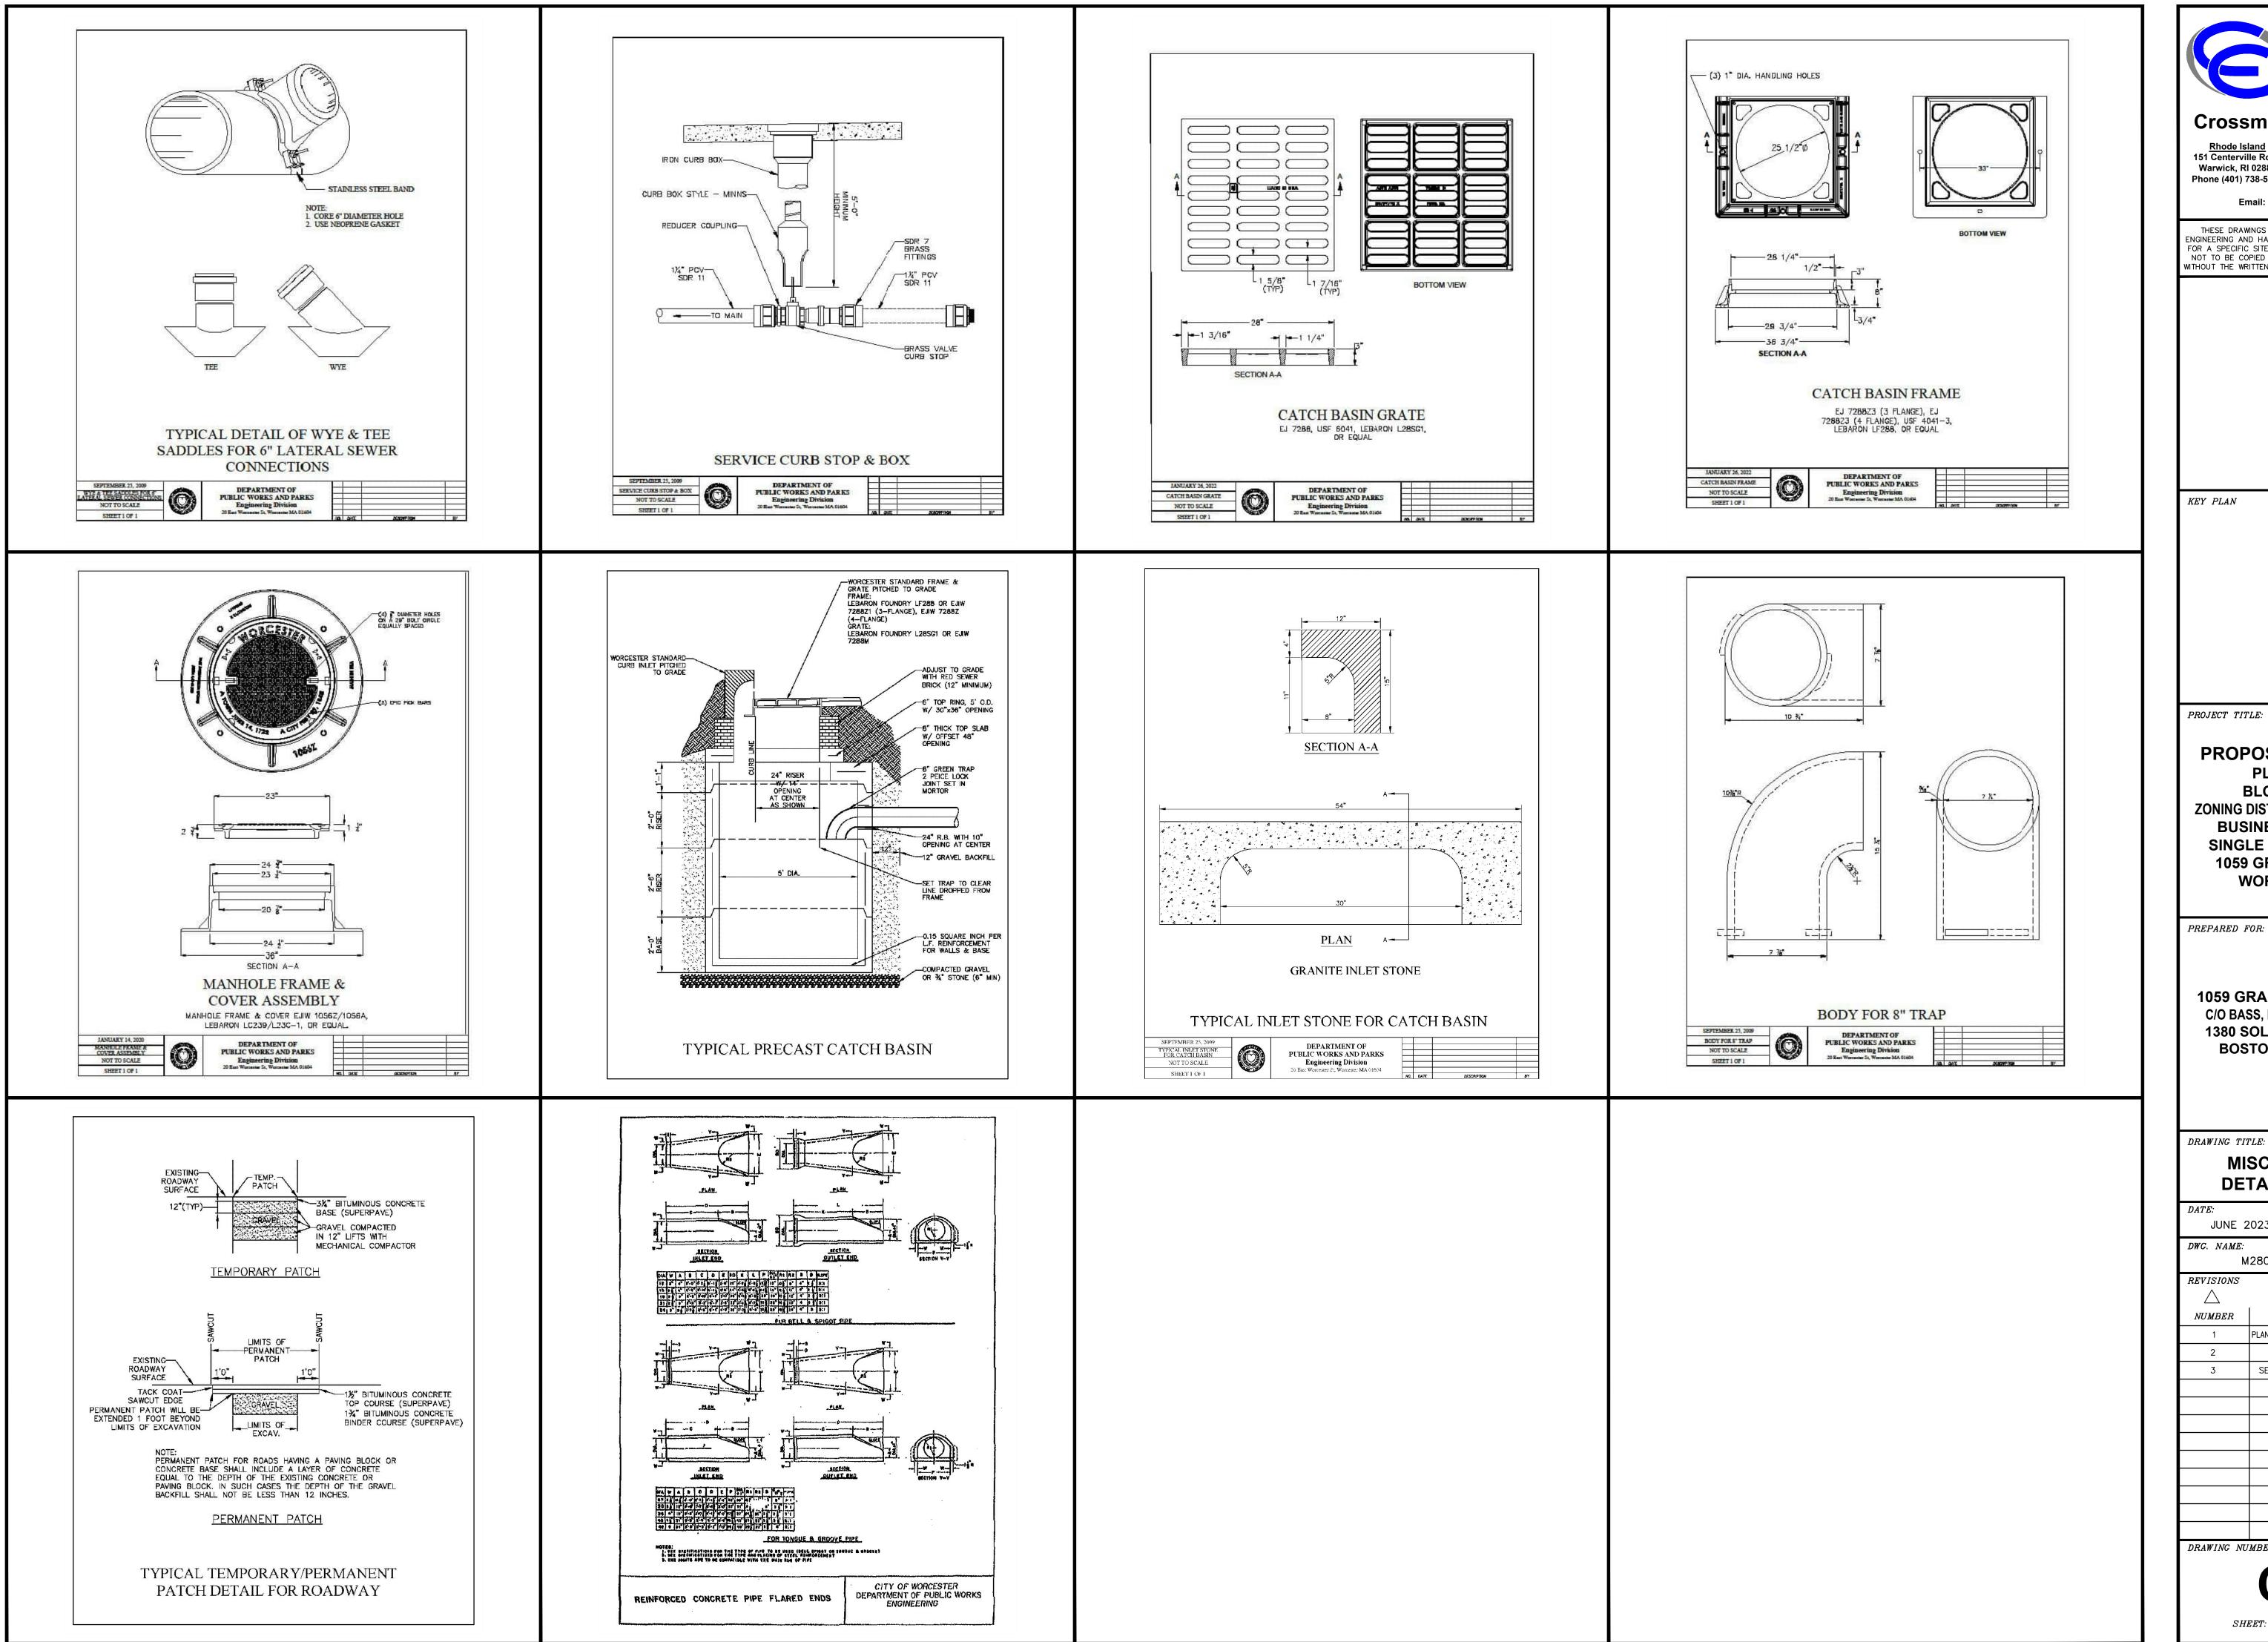



Site Planning Surveying Permitting Landscape Architecture

Crossman Engineering

151 Centerville Road 103 Commonwealth Avenue Warwick, RI 02886 North Attleboro, MA 02763 Phone (401) 738-5660 Phone (508) 695-1700

Email: cei@crossmaneng.com

THESE DRAWINGS ARE THE PROPERTY OF CROSSMAN ENGINEERING AND HAVE BEEN PREPARED FOR THEIR CLIENT FOR A SPECIFIC SITE AND PROJECT. THESE DRAWINGS ARE NOT TO BE COPIED OR USED FOR ANY OTHER PURPOSE WITHOUT THE WRITTEN CONSENT OF CROSSMAN ENGINEERING

PROPOSED CAR WASH PLAT MAP 38, BLOCK 35 LOT 2 **ZONING DISTRICTS: BL-1.0 and RL-7 BUSINESS LIMITED and** SINGLE FAMILY DISTRICT 1059 GRAFTON STREET

**WORCESTER, MA** 

PREPARED FOR:

**1059 GRAFTON STREET, LLC** C/O BASS, DOHERTY & FINKS, P.C. 1380 SOLDIERS FIELD ROAD **BOSTON, MA 02135-1023** 

DRAWING TITLE:

**MISCELLANEOUS DETAIL PLAN No. 6** 

JUNE 2023 AS SHOWN DWG. NAME: M280-C14-DETAIL6-R3.dwg

REVISIONS


1	PLANNING BOARD COMMENTS	08/01/23
2	CITY COMMENTS	08/18/23
3	SEWER CONNECTION	01/25/24

REMARKS

DATE

DRAWING NUMBER

SHEET: 15 OF: 21

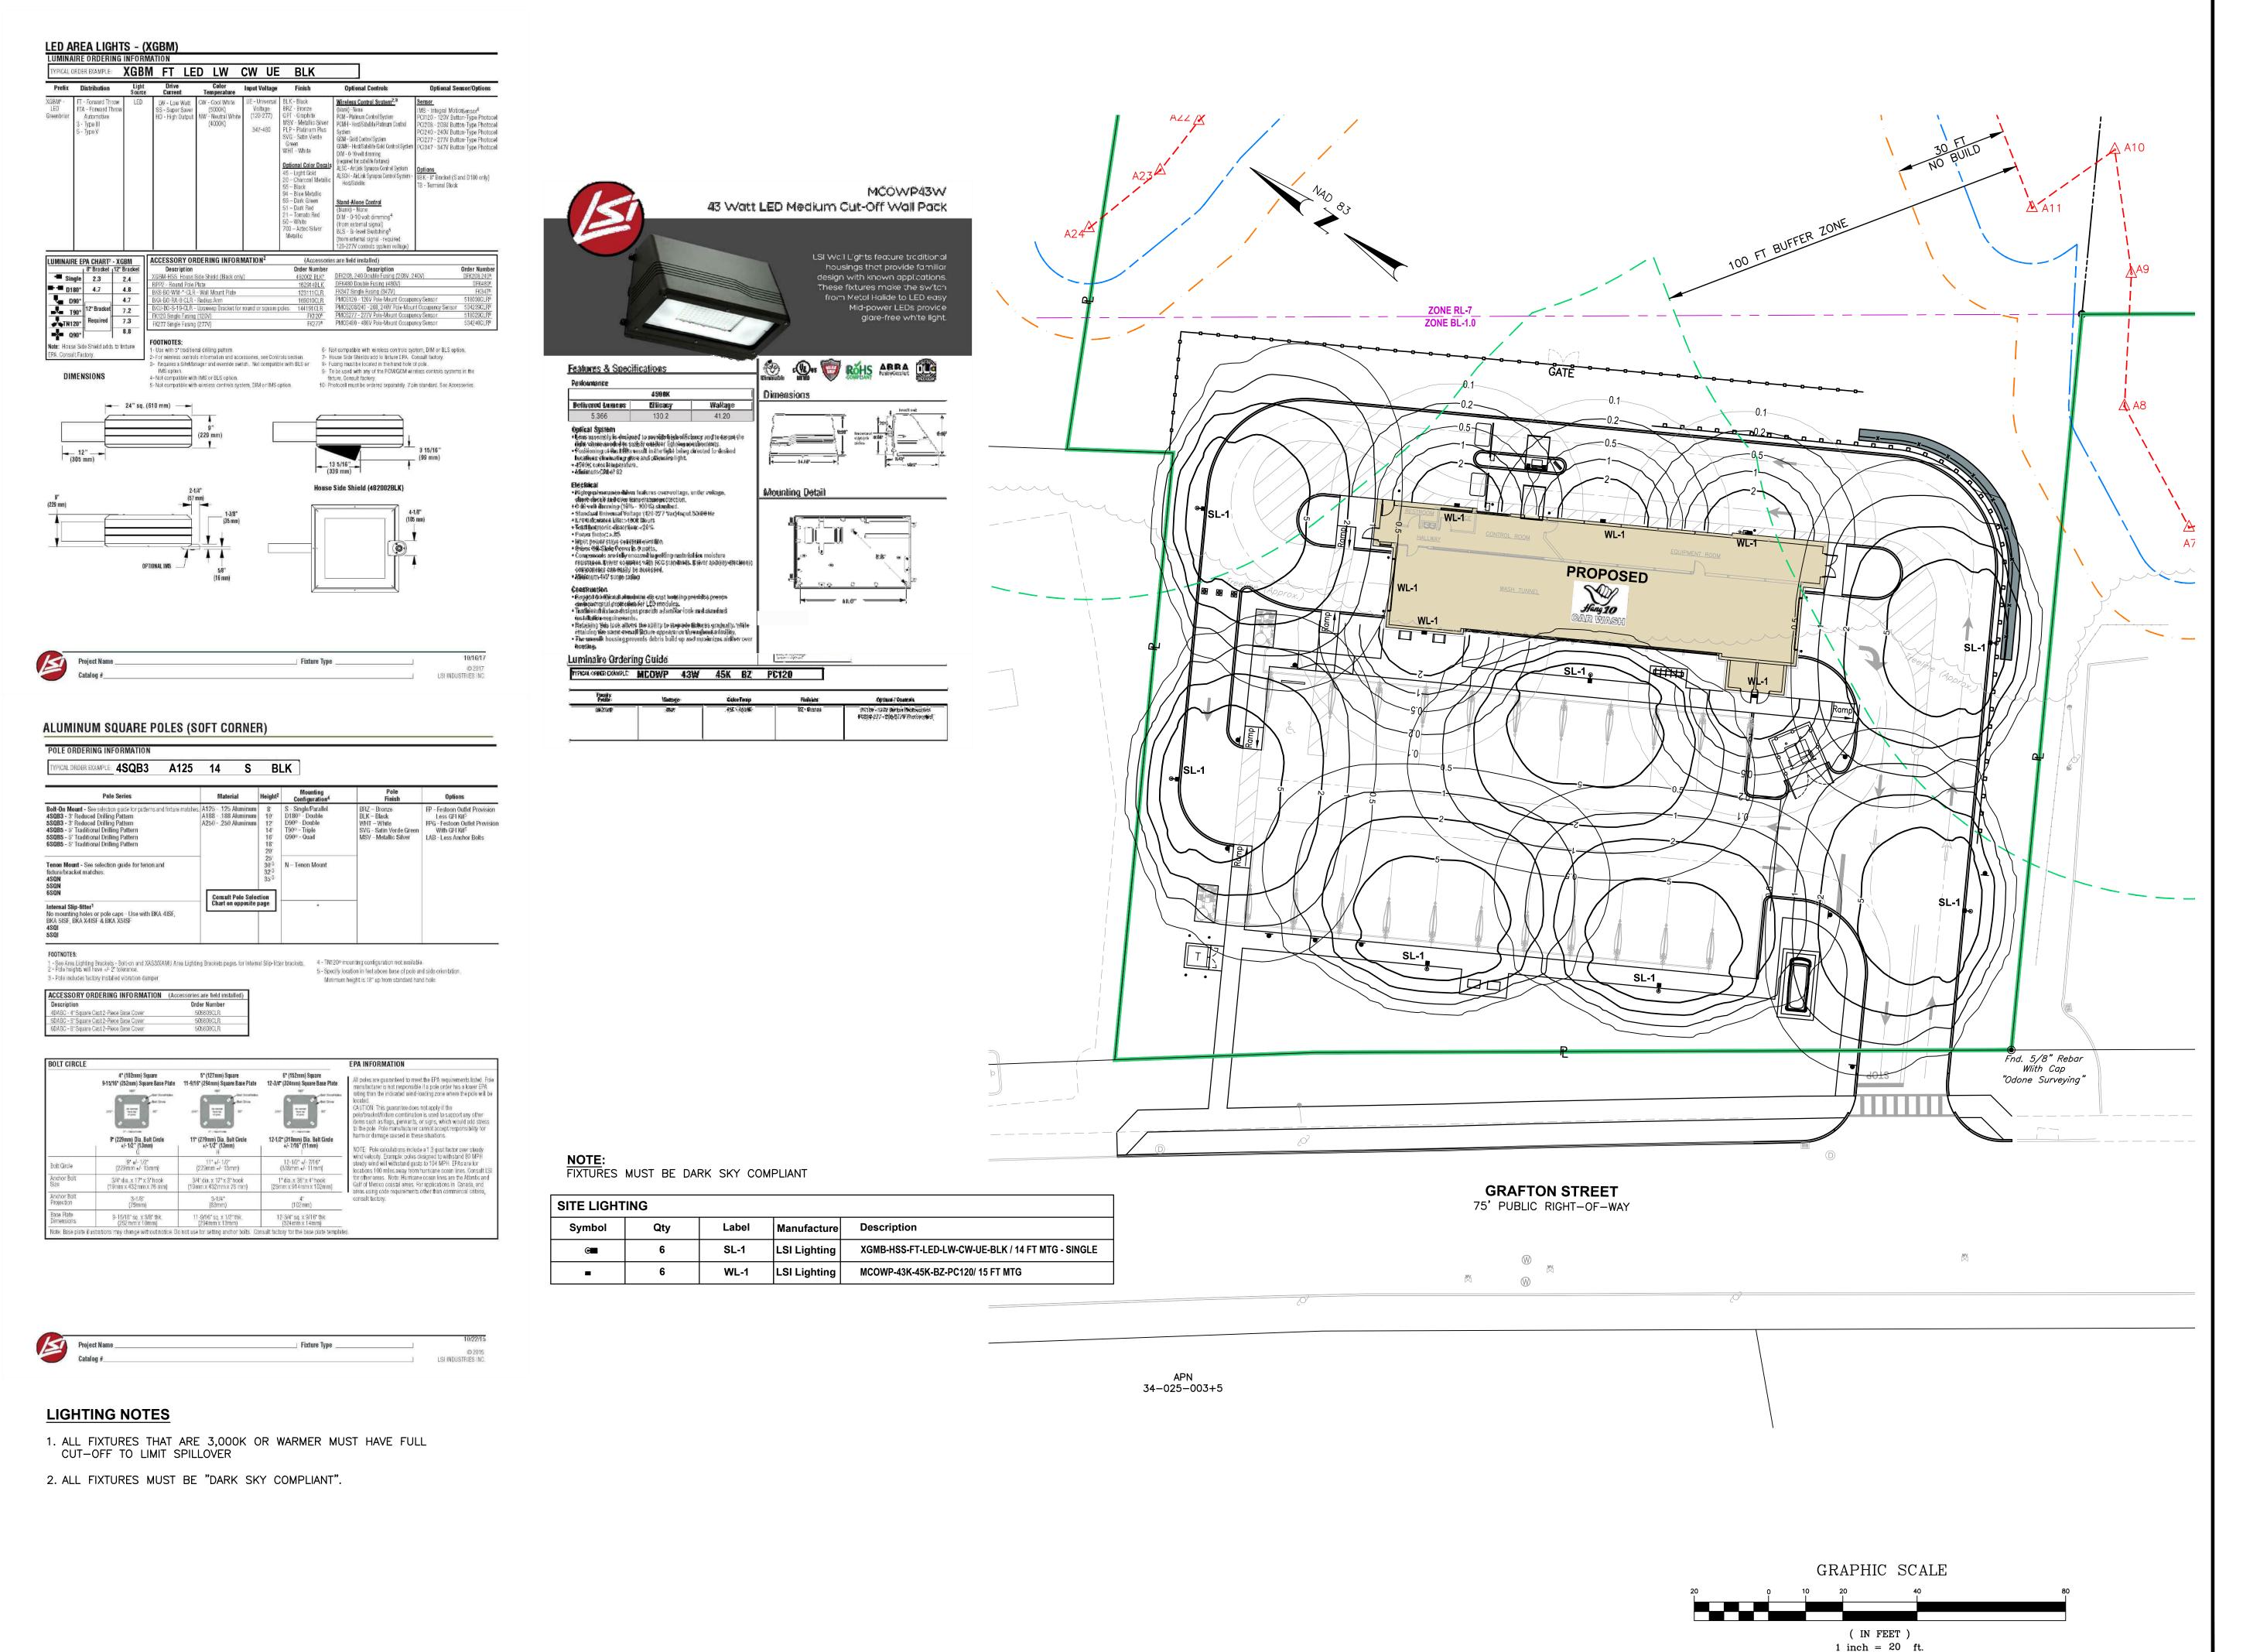

Civil Transportation Environmental Site Planning Surveying Permitting

 Landscape Architecture Crossman Engineering

151 Centerville Road 103 Commonwealth Avenue Warwick, RI 02886 North Attleboro, MA 02763 Phone (401) 738-5660 Phone (508) 695-1700

Email: cei@crossmaneng.com

THESE DRAWINGS ARE THE PROPERTY OF CROSSMAN ENGINEERING AND HAVE BEEN PREPARED FOR THEIR CLIENT FOR A SPECIFIC SITE AND PROJECT. THESE DRAWINGS ARE NOT TO BE COPIED OR USED FOR ANY OTHER PURPOSE WITHOUT THE WRITTEN CONSENT OF CROSSMAN ENGINEERING

KEY PLAN

PROJECT TITLE:

PROPOSED CAR WASH PLAT MAP 38, BLOCK 35 LOT 2 **ZONING DISTRICTS: BL-1.0 and RL-7 BUSINESS LIMITED and** SINGLE FAMILY DISTRICT 1059 GRAFTON STREET **WORCESTER, MA** 

PREPARED FOR:

1059 GRAFTON STREET, LLC C/O BASS, DOHERTY & FINKS, P.C. 1380 SOLDIERS FIELD ROAD **BOSTON, MA 02135-1023** 

DRAWING TITLE:

SITE LIGHTING PLAN

JUNE 2023 1"=20' DWG. NAME:


M280-E01-LIGHT-R3.dwg

REVISIONS

NUMBERREMARKSDATEPLANNING BOARD COMMENTS 08/01/23 CITY COMMENTS 08/18/23 SEWER CONNECTION 01/25/24

DRAWING NUMBER

SHEET: 16 OF: 21

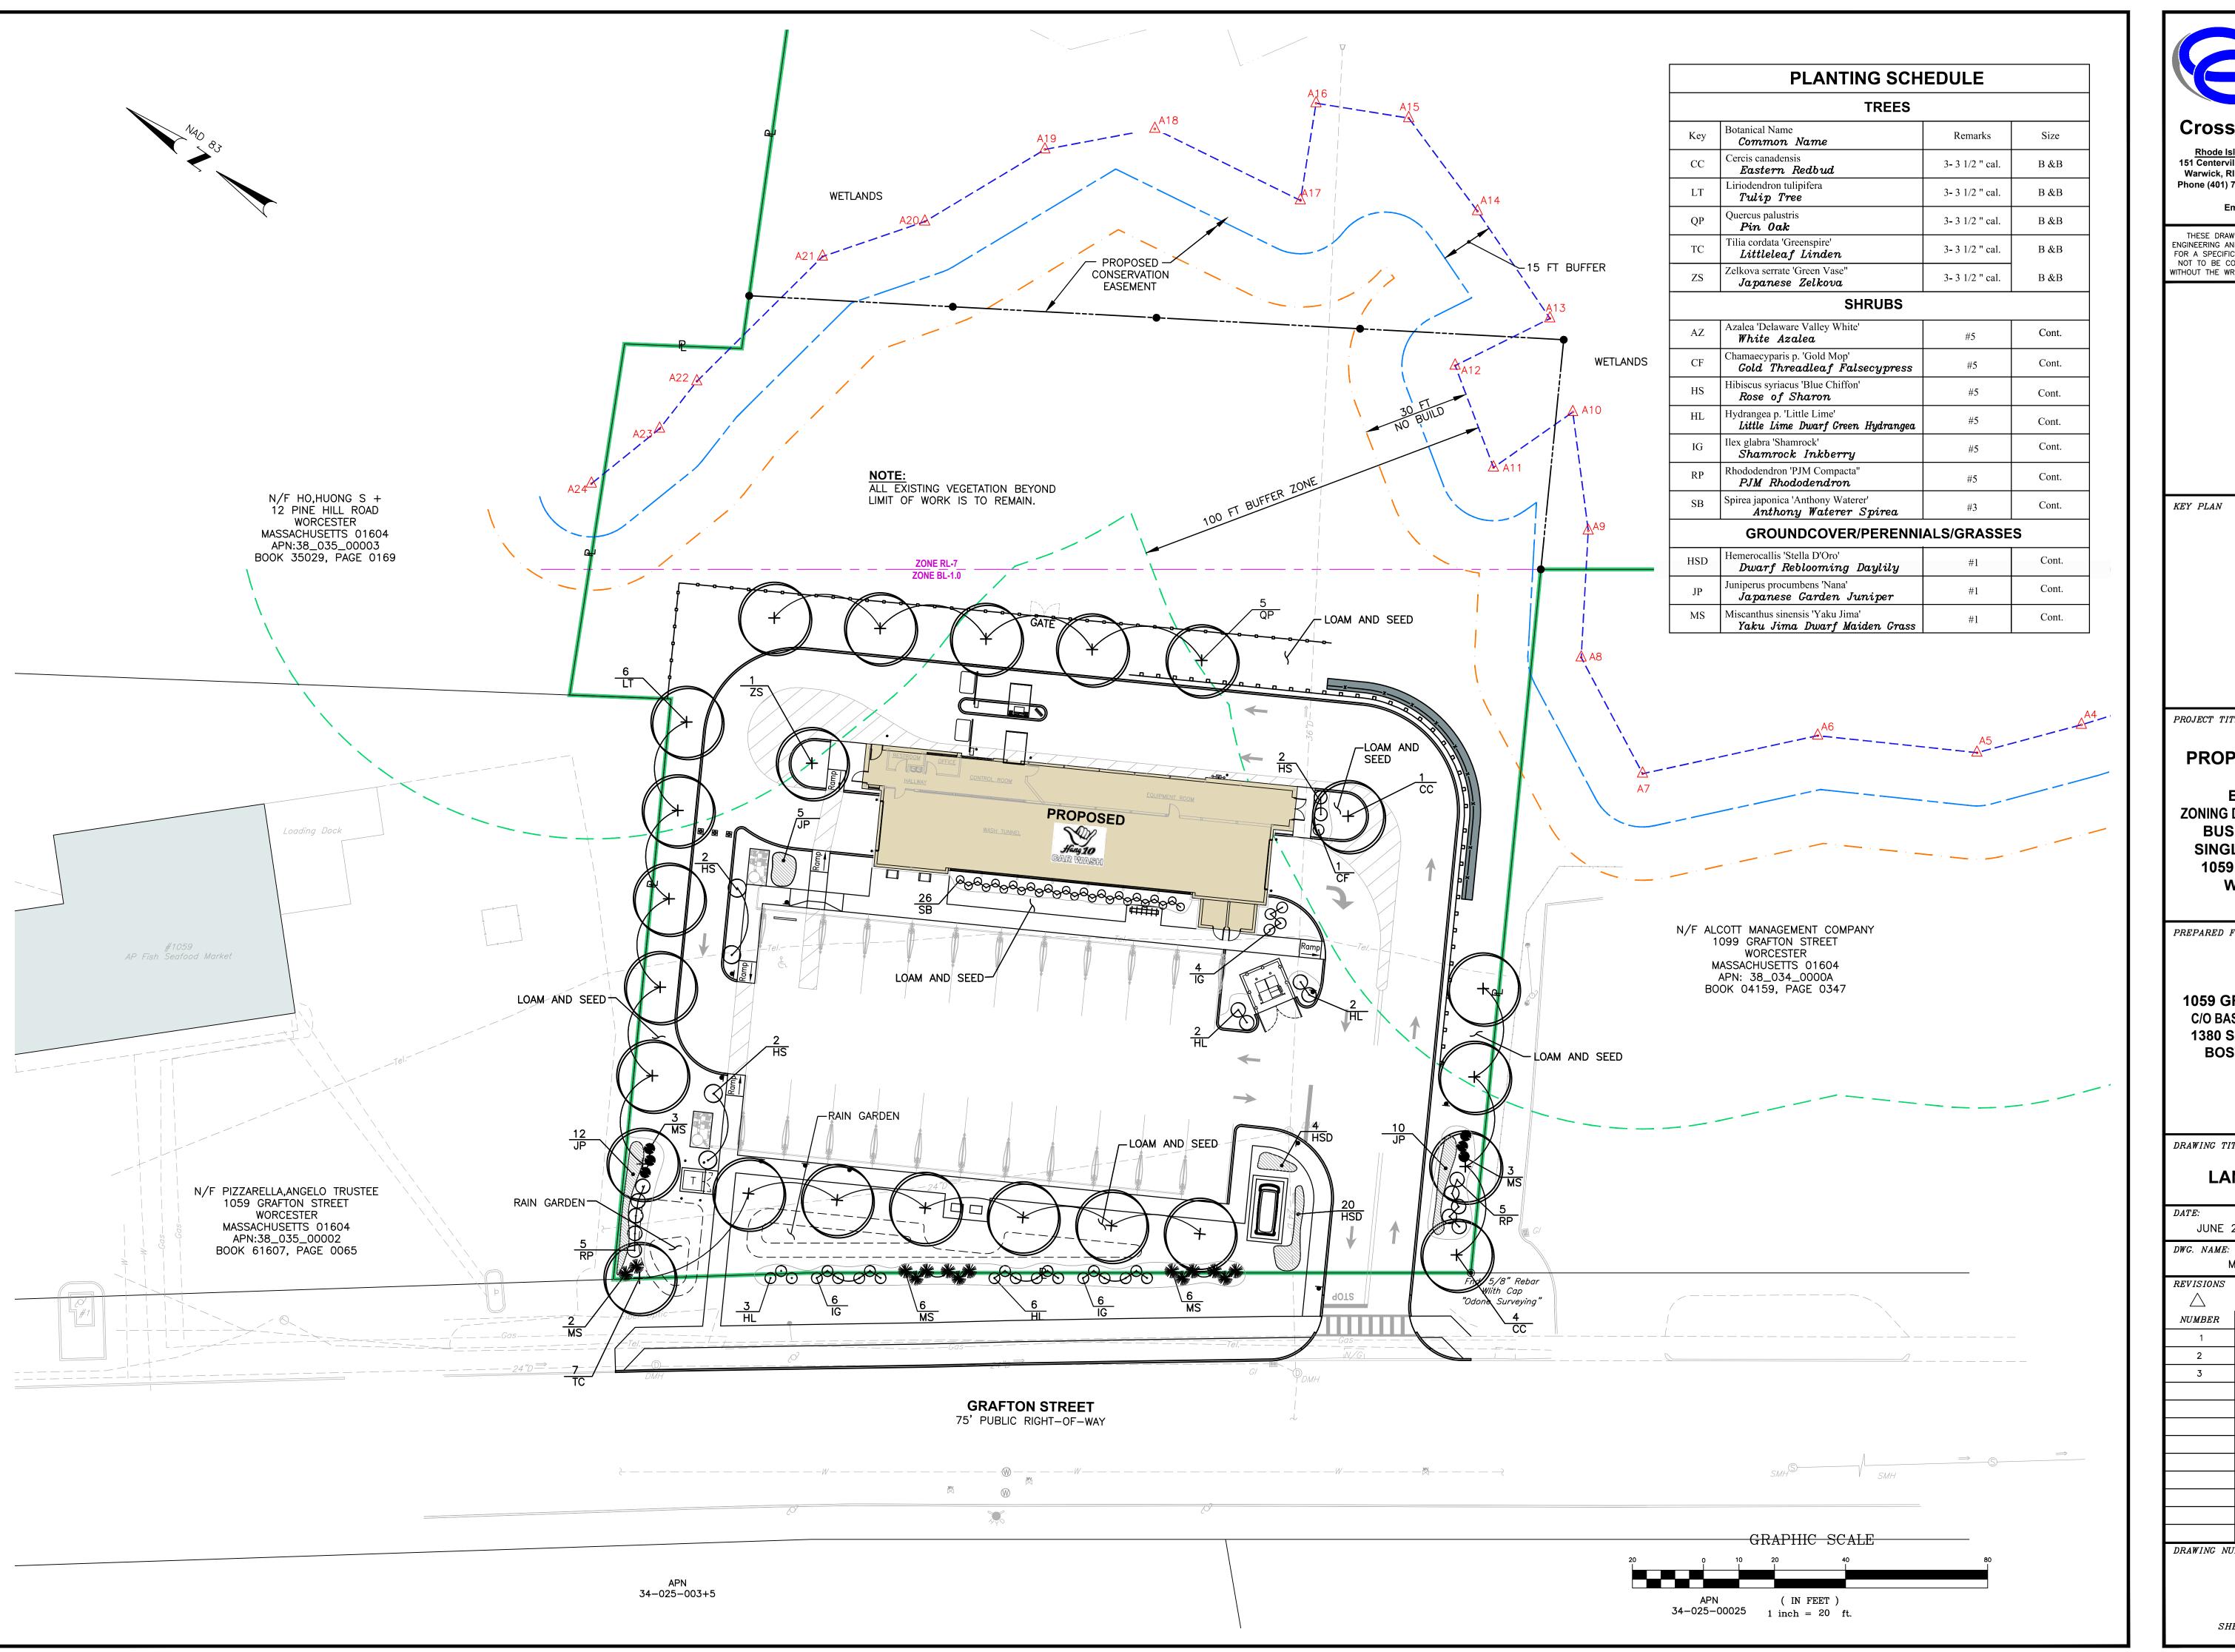



• Transportation Environmental Site Planning Surveying

**Crossman Engineering** 

Rhode Island Massachusetts

151 Centerville Road 103 Commonwealth Avenue Warwick, RI 02886 North Attleboro, MA 02763 Phone (401) 738-5660 Phone (508) 695-1700

Email: cei@crossmaneng.com

THESE DRAWINGS ARE THE PROPERTY OF CROSSMAN ENGINEERING AND HAVE BEEN PREPARED FOR THEIR CLIENT FOR A SPECIFIC SITE AND PROJECT. THESE DRAWINGS ARE NOT TO BE COPIED OR USED FOR ANY OTHER PURPOSE WITHOUT THE WRITTEN CONSENT OF CROSSMAN ENGINEERING

KEY PLAN

PROJECT TITLE:

PROPOSED CAR WASH PLAT MAP 38, BLOCK 35 LOT 2 **ZONING DISTRICTS: BL-1.0 and RL-7 BUSINESS LIMITED and** SINGLE FAMILY DISTRICT **1059 GRAFTON STREET** 

**WORCESTER, MA** 

PREPARED FOR:

1059 GRAFTON STREET, LLC C/O BASS, DOHERTY & FINKS, P.C. 1380 SOLDIERS FIELD ROAD **BOSTON, MA 02135-1023** 

DRAWING TITLE:

## LANDSCAPE PLAN

JUNE 2023 1"=20'


M280-L01-LAND-R3.dwg

REVISIONS

REMARKS DATE

PLANNING BOARD COMMENTS 08/01/23 08/18/23 CITY COMMENTS 01/25/24 SESMEWRERCONMERCTISON

DRAWING NUMBER

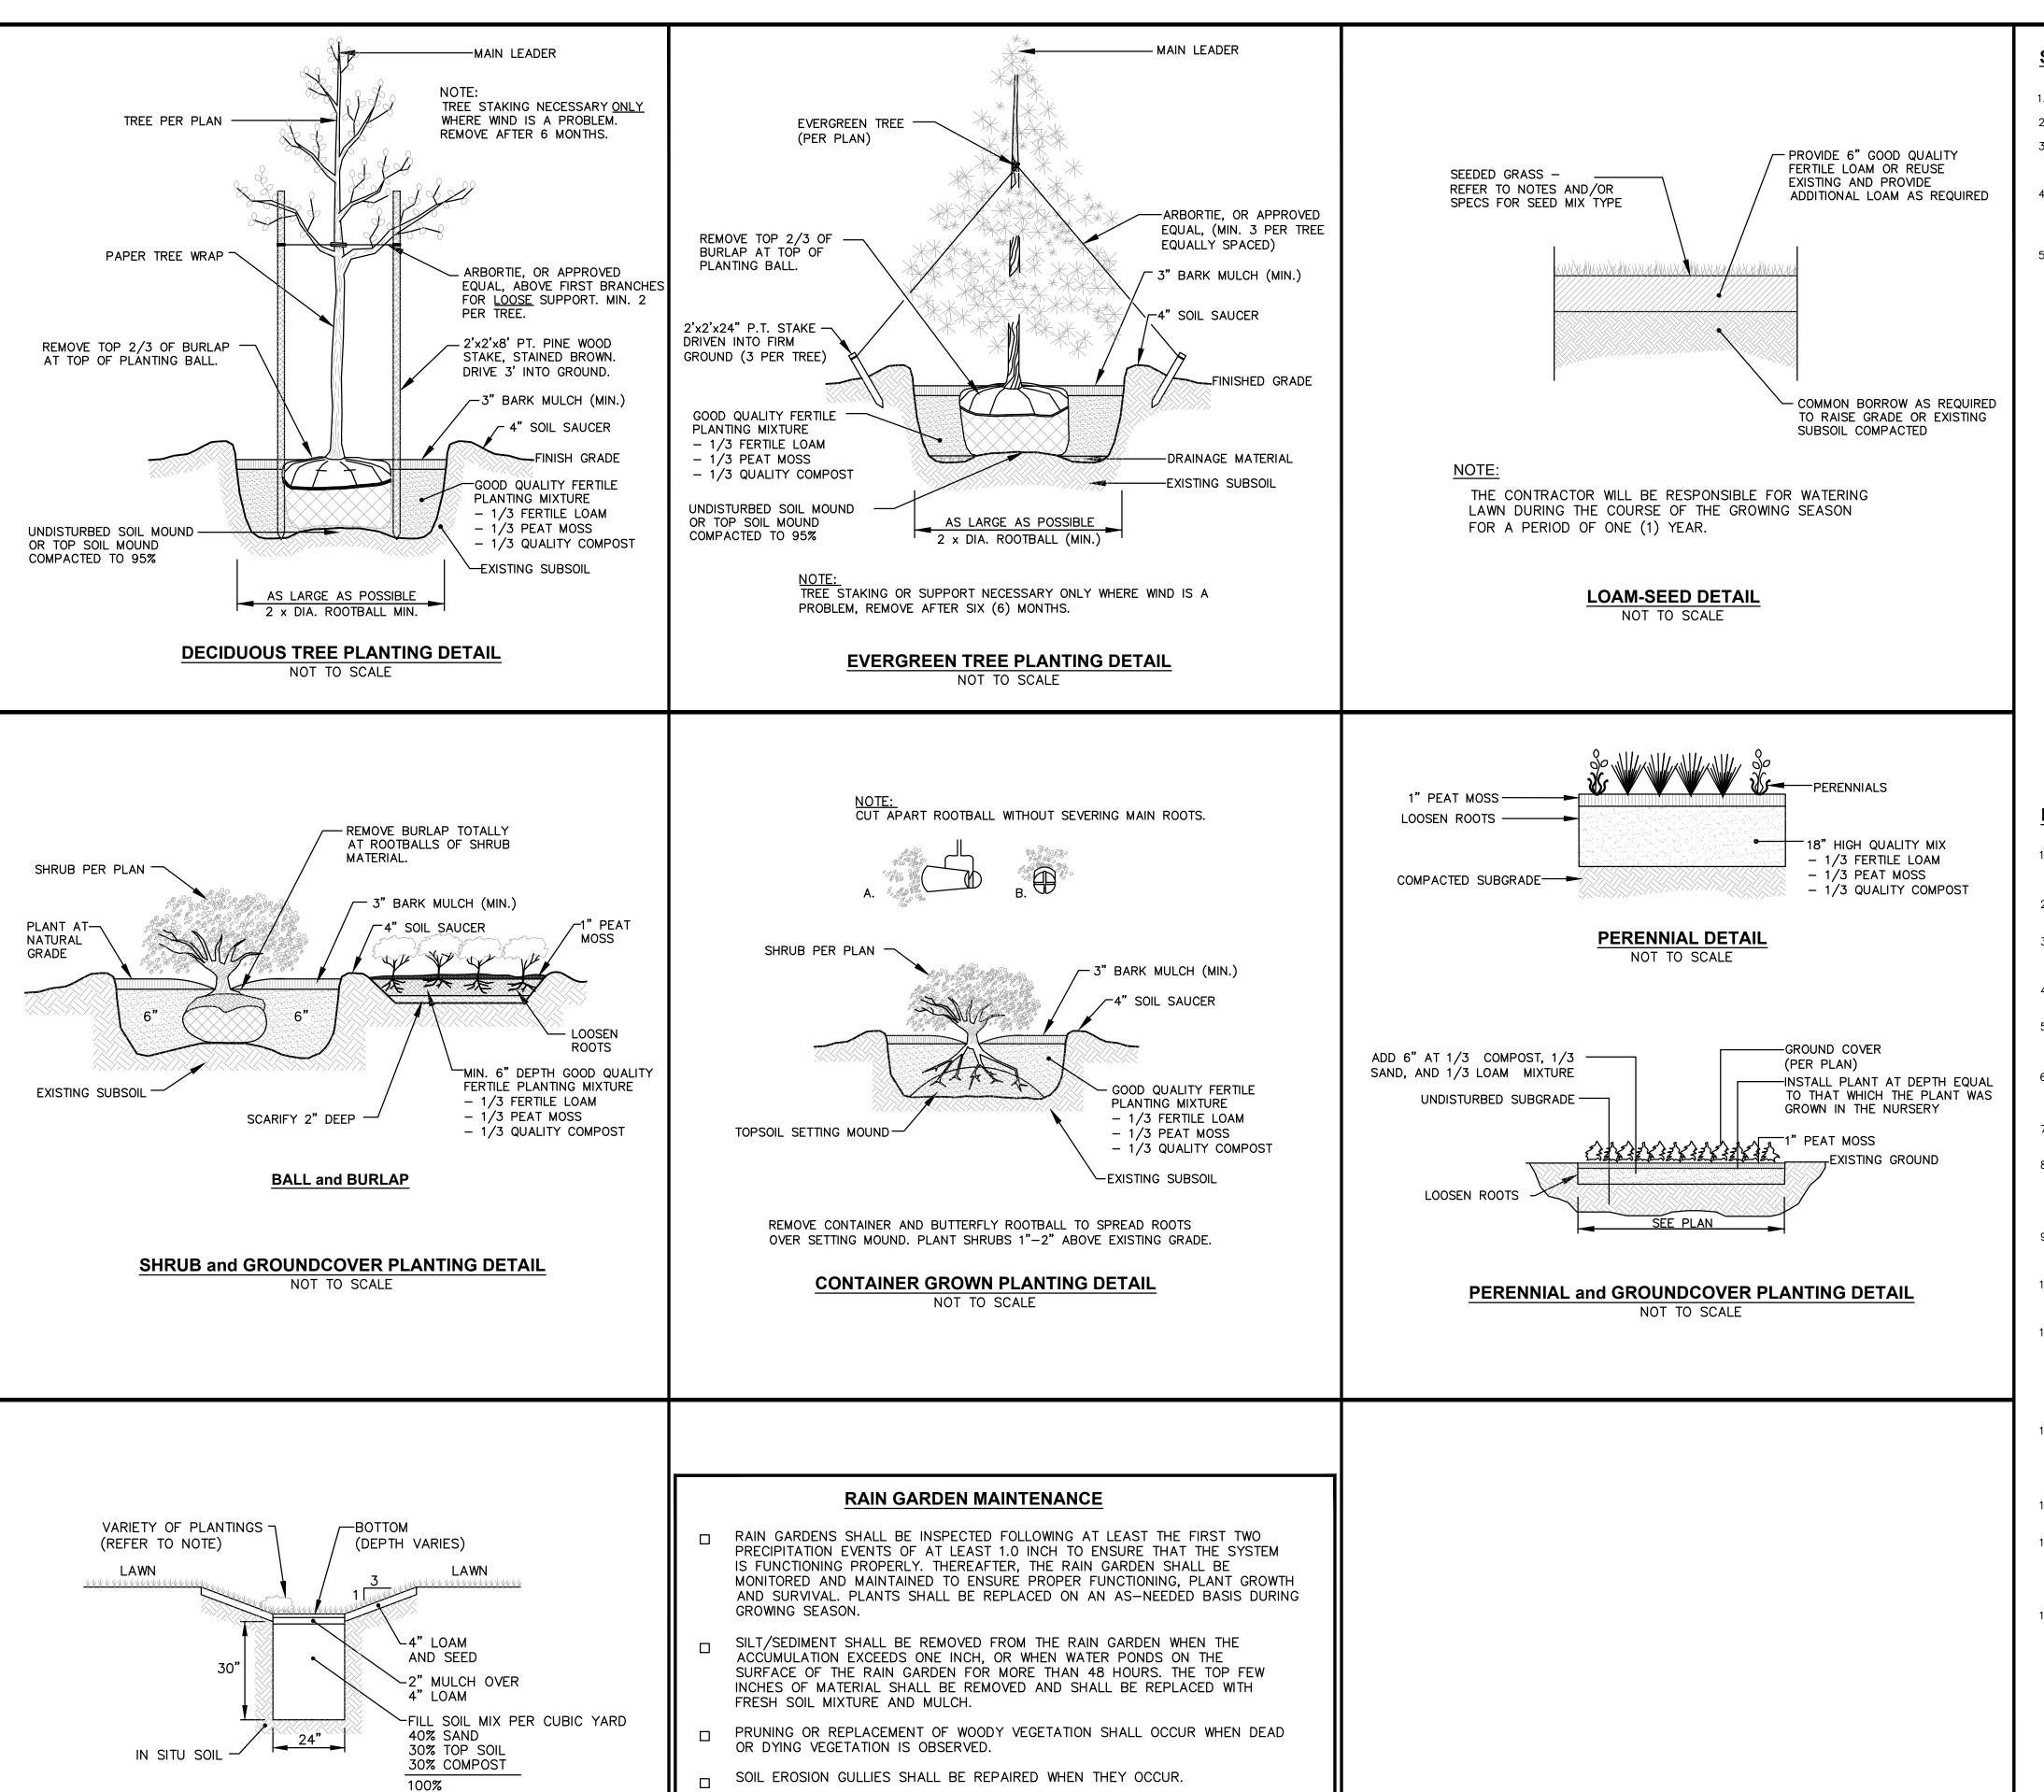

#### **SEEDING NOTES**

- 1. LOAM SHALL BE SPREAD TO A MINIMUM DEPTH OF 6" OVER ALL AREAS DESIGNATED ON PLANS.
- 2. SHAPE AND SMOOTH THE SURFACE TO THE LINES AND GRADES AS SHOWN ON PLANS.
- 3. FERTILIZE WITH 10-10-10 OR EQUIVALENT ANALYSIS. AT LEAST 40% OF THE FERTILIZER NITROGEN SHALL BE IN A SLOW RELEASE FORM. INCORPORATE THE FERTILIZER INTO THE TOP 3 TO 4 INCHES OF THE PLANTING SOIL. APPLY AT THE RATE OF 8 POUNDS PER 1,000 SQUARE FEET AT SEEDING.
- 4. LIME: SPREAD EVENLY AND WORK INTO THE SOIL DURING PREPARATION OF SEED BED AT THE RATE OF ONE TON PER ACRE. INCORPORATE INTO THE SOIL BY DICING OR OTHER APPROVED METHOD. DISTRIBUTE LIME UNIFORMLY AND WORK INTO TOP 4 INCHES OF TOP SOIL (MINIMUM) AND UNIFORMLY BLEND BY DICING OR ROTOTILLING.
- A. RATE OF APPLICATION OF SEED SHALL BE 8 POUNDS PER 1,000 SQUARE FEET OR AS INDICATED
- B. SEEDING SHALL BE DONE IN ACCORDANCE WITH THE MANUFACTURER'S SPECIFICATIONS AND INSTRUCTIONS, AND ONLY DURING THE FOLLOWING DATES: SPRING SEEDING: MARCH 15 TO MAY 31 FALL SEEDING: AUGUST 15 TO OCTOBER 15
- C. THE CONTRACTOR SHALL KEEP ALL SEEDED AREAS WATERED AND IN GOOD CONDITION, RESEEDING IF AND WHEN NECESSARY FOR AN 8 WEEK PERIOD OR UNTIL A GOOD, HEALTHY, UNIFORM GROWTH IS ESTABLISHED OVER THE ENTIRE AREA. THE CONTRACTOR SHALL ALSO MAINTAIN THESE AREAS IN AN APPROVED CONDITION UNTIL PROVISIONAL ACCEPTANCE.
- D. DURING THIS PERIOD, WATER TURF AS NECESSARY TO MAINTAIN AN ADEQUATE SUPPLY OF MOISTURE WITHIN THE ROOT ZONE. AN ADEQUATE SUPPLY OF MOISTURE IS EQUIVALENT OF ONE INCH OF ABSORBED WATER PER WEEK THAT IS DELIVERED AT WEEKLY INTERVALS IN THE FORM OF NATURAL RAIN OR IS AUGMENTED AS REQUIRED BY PERIODIC WATERING.
- E. OVERSEED WHEN NECESSARY TO PROMOTE GRASS GROWTH.
- F. REPLANT AREAS VOID OF TURF ONE SQUARE FOOT OR LARGER.
- a. SEED <u>ALL</u> AREAS DESIGNATED ON PLAN AS WELL AS <u>ALL</u> DISTURBED EXISTING AREAS WITH THE

#### SEED MIX No. 1

ENDOPHYTE ENCHANCED MIX (MOWED AREAS) **TYPE** % BY WEIGHT IMPROVED PER. RYE 30% TURF TYPE TALL FESCUE 30% CHEWINGS FESCUE 30% 10% KY. BLUEGRASS 98/85

APPLICATION RATE = 200 lbs. / ACRE

#### LANDSCAPE CONSTRUCTION NOTES

- . FURNISH AND INSTALL ALL PLANTS SHOWN ON THE DRAWINGS SPECIFIED HEREIN, AND IN THE QUANTITIES LISTED ON THE PLANT LIST. NO SUBSTITUTIONS WILL BE PERMITTED, UNLESS APPROVED BY THE LANDSCAPE ARCHITECT
- 2. LOAM TO BE SCREENED, GOOD QUALITY, FERTILE, FREE OF WEEDS, STICKS, STONES OVER 3/4", AND ROOTS. SPREAD TO A MINIMUM OF 6" OVER ALL PLANTED AREAS.
- 3. BIO-DETENTION AREAS-PLANTING SOIL AND MULCH: LOAMY SAND TO A SANDY LOAM-80% SAND <20% SILT, <2% CLAY. WELL AGED GRADED COMPOST (25% OF SOIL MIX). WELL AGED, AERATED DARK BROWN HARD-WOOD MULCH (AGED 6 MONTHS).
- 4. NURSERY STOCK SHALL MEET THE STANDARDS OF THE AMERICAN NURSERY AND LANDSCAPE ASSOCIATION AS TO GRADING AND QUALITY.
- 5. ONLY NURSERY-GROWN PLANTS, GROWN IN ACCORDANCE WITH ACCEPTED HORTICULTURAL PRACTICES, AND GROWN UNDER CLIMATIC CONDITIONS SIMILAR TO TO THOSE IN THE LOCALITY OF THE PROJECT FOR AT LEAST TWO (2) YEARS, WILL BE ACCEPTED.
- 6. CALIPER MEASURMENTS FOR ALL NEW PLANT STOCK SHALL BE TAKEN SIX (6) INCHES ABOVE GRADE FOR TREES UNDER FOUR (4) INCHES AND TWELVE (12) INCHES ABOVE GRADE FOR TREES OVER
- 7. ALL TREES SHALL BE A MINIMUM OF SEVEN (7) FEET ABOVE FINISHED GRADE WHEN TREES ARE LOCATED WITHIN VEHICULAR AND PEDESTRIAN TRAVEL WAYS.
- 8. SET PLANTS PLUMB AND AT A LEVEL THAT AFTER SETTLEMENT THEY BEAR THE SAME RELATION TO THE SURROUNDING GROUND AS THEY BORE TO THE GROUND FROM WHICH THEY WERE DUG. SETTLE BACKFILL MATERIAL FOR PLANTS, THOROUGHLY AND PROPERLY BY FIRMING OR TAMPING. FORM SAUCERS, CAPABLE OF HOLDING WATER ABOUT INDIVIDUAL PLANTS, BY PLACING RIDGES OF PLANTING
- 9. STAKE ALL TREES OVER 5 FEET AS SHOWN ON PLANS. REMOVE STAKES AT THE END OF THE GUARANTEE PERIOD.
- 10. WATERING: WATER ALL PLANTS WITHIN 48 HOURS AFTER PLANTING. IF CONDITIONS WARRANT, AND AS MANY TIMES THEREAFTER TO SUSTAIN HEALTHY CONDITIONS UNTIL LANDSCAPE INSTALLATION IS COMPLETED. SATURATE THE SOIL AROUND EACH PLANT THOROUGHLY AT EACH WATERING.
- 11. PRUNING: PRUNE PLANTS, AS DIRECTED BY OWNER, AT THE PROJECT SITE BEFORE OR IMMEDIATELY AFTER PLANTING IN ACCORDANCE WITH THE BEST HORTICULTURAL PRACTICE. CUT BROKEN, DEAD OR INJURED BRANCHES IMMEDIATELY ABOVE THE STEM COLLAR ON THE TRUNK OR LIMB. PRUNE ALL BROKEN ROOTS ON THE PLANT SIDE OF THE BREAK, PAINT CUTS OVER 3/4" IN DIAMETER WITH TREE WOUND PAINT. PRUNING SHALL <u>NOT</u> DEFORM OR OTHERWISE DESTROY THE TYPICAL SHAPE OR SYMMETRY OF THE PLANT, AND SHALL <u>NOT</u> REDUCE THE HEIGHT BY MORE THAN ONE—THIRD. DO <u>NOT</u> CUT BACK THE LEADER OF THE PLANT UNLESS DIRECTED BY THE LANDSCAPE ARCHITECT.
- 12. FERTILIZING: FERTILIZE SHRUB BEDS WITH 10-10-10 FERTILIZER BROADCAST PER MANUFACTURER'S RATE. APPLY THE FERTILIZER UNIFORMLY TO THE SURFACE BEDS AND WORK INTO THE UPPER TWO INCHES OF SOIL. FERTILIZE INDIVIDUAL TREES AS PER MANUFACTURER'S INSTRUCTIONS. APPLY A SECOND APPLICATION OF FERTILIZER TO ALL PLANT ITEMS AT THE SAME SPECIFIED RATES OVER THE MULCH AT THE END OF A SIX (6) WEEK PERIOD (WITH AVERAGE RAINFALL).
- 13. LIMING: ADD POWDERED LIME EVERY SIX MONTHS OR SLOW RELEASE GRANULAR LIME-AS PER MANUFACTURER'S INSTRUCTION.
- 14. MULCHING: WITHIN A 72 HOUR PERIOD AFTER PLANTING, COVER ALL PLANTED AREAS WITH TREFLAN HERBICIDE OR EQUIVILENT GRANULAR PRE-EMERGENT HERBICIDE IN ACCORDANCE WITH THE MANUFACTURER'S INSTRUCTIONS. COVER WITH 3" DEPTH OF NATURAL BROWN SHREDDED BARK MULCH. NO RED OR DYED MULCH IS TO BE USED. MULCH SHOULD BE PULLED ONE INCH AWAY FROM PLANT TRUNK OR STEM, AND NOT ALLOWED TO REST DIRECTLY AGAINST THE TRUNK OR STEM.
- 15. GUARANTEE: ALL PLANTS FURNISHED BY THE CONTRACTOR SHALL BE GUARANTEED FOR A PERIOD OF ONE (1) YEAR AFTER PRELIMINARY INSPECTION AND SHALL BE ALIVE AND IN SATISFACTORY GROWTH AT THE END OF THE GUARANTEE PERIOD. ALL DEAD OR DYING PLANT MATERIAL SHALL BE REPLACED AT ONCE BY THE CONTRACTOR, AT NO ADDITIONAL COST TO THE OWNER.



Surveying Permitting Landscape Architecture

Site Planning

**Crossman Engineering** 

151 Centerville Road 103 Commonwealth Avenue Warwick, RI 02886 North Attleboro, MA 02763 Phone (401) 738-5660 Phone (508) 695-1700

Email: cei@crossmaneng.com

THESE DRAWINGS ARE THE PROPERTY OF CROSSMAN NGINEERING AND HAVE BEEN PREPARED FOR THEIR CLIENT FOR A SPECIFIC SITE AND PROJECT. THESE DRAWINGS AR NOT TO BE COPIED OR USED FOR ANY OTHER PURPOSE WITHOUT THE WRITTEN CONSENT OF CROSSMAN ENGINEERING

KEY PLAN

PROJECT TITLE:

PROPOSED CAR WASH PLAT MAP 38, **BLOCK 35 LOT 2 ZONING DISTRICTS: BL-1.0 and RL-7 BUSINESS LIMITED and** SINGLE FAMILY DISTRICT 1059 GRAFTON STREET WORCESTER, MA

PREPARED FOR:

**1059 GRAFTON STREET. LLC** C/O BASS, DOHERTY & FINKS, P.C. 1380 SOLDIERS FIELD ROAD **BOSTON, MA 02135-1023** 

DRAWING TITLE:

LANDSCAPE **DETAIL PLAN** 

JUNE 2023 NO SCALE

DWG. NAME:

M280-L02-LNDET-R3.dwg

REVISIONS

NUMBERREMARKS DATEPLANNING BOARD COMMENTS 08/01/23 CITY COMMENTS 08/18/23 SEWER CONNECTION 01/25/24

DRAWING NUMBER

SHEET: 18 OF: 21

- SOIL EROSION GULLIES SHALL BE REPAIRED WHEN THEY OCCUR.
- FERTILIZER OR PESTICIDES SHALL NOT BE APPLIED TO PLANTS WITHIN RAIN
- PERENNIAL PLANTS AND GROUND COVERS SHALL BE REPLACED AS NECESSARY TO MAINTAIN AN ADEQUATE VEGETATED GROUND COVER. ANNUAL PLANTS MAY ALSO BE USED TO MAINTAIN GROUND COVER.


#### PLANTING NOTE

RAIN GARDEN SHALL BE PLANTED WITH THE FOLLOWING (OR EQUAL):

Green-Headed Coneflower (Reudbeckia laciniata) (10) Meadowsweet (Spirea alba) (10) Switchgrass (Panicum vigatum) (10) Arrowwood Viburnum (Viburnum dentatum) (3) Highbush Blueberry (Vaccinium corymbosum) (3)

TYPICAL RAIN GARDEN DETAIL

NOT TO SCALE

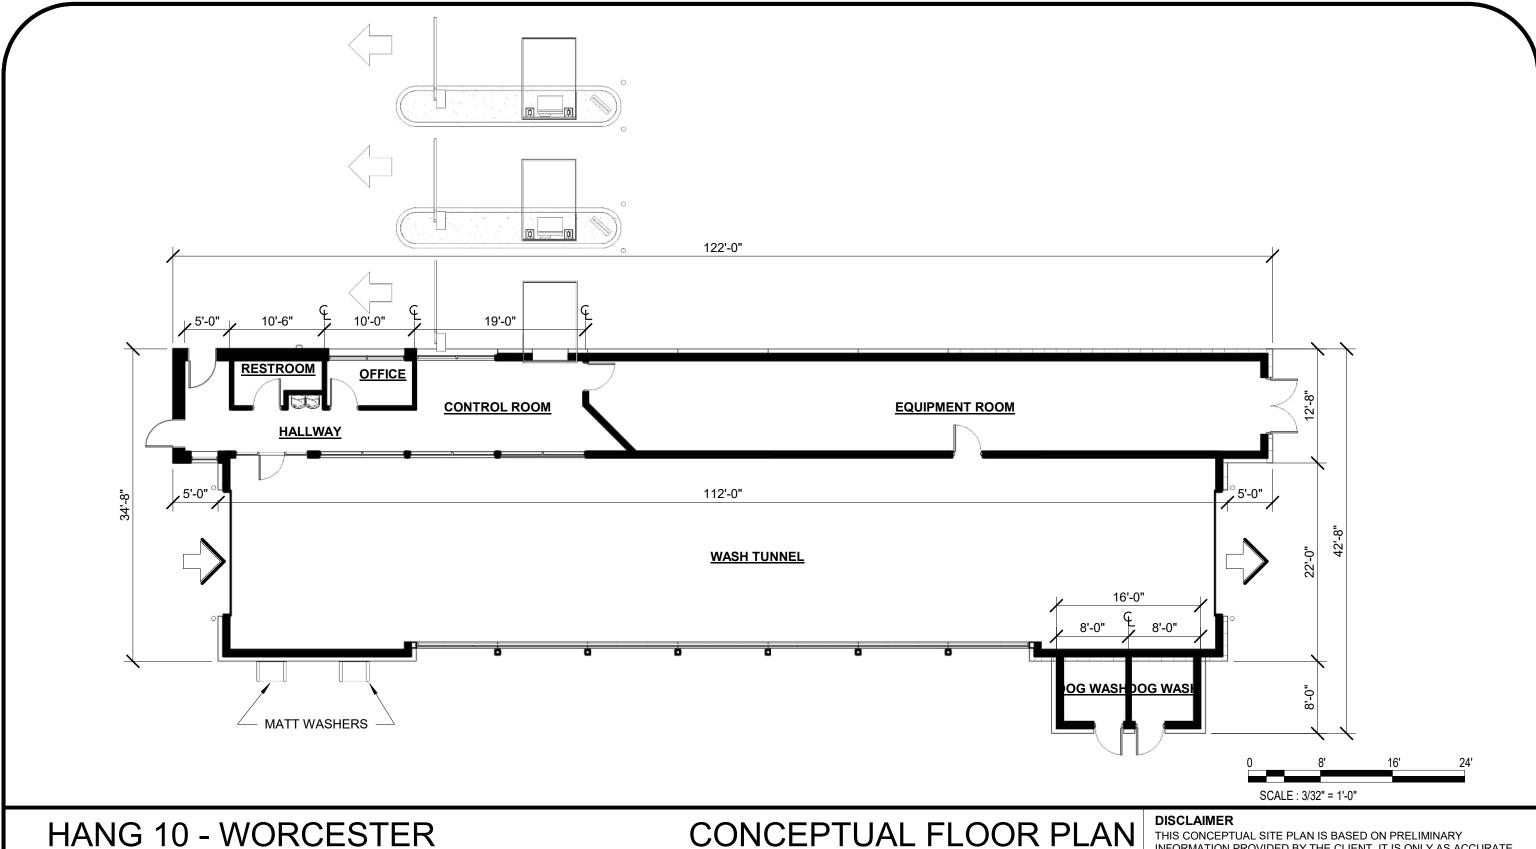

# HANG 10 - WORCESTER

1059 GRAFTON ST

WORCESTER, MA

PROJECT NO.: DATE:


PDP23.CWB.002 01/27/2023

DRAWN BY: MMK CHECKED BY: JTK



#### **DISCLAIMER**

THIS CONCEPTUAL SITE PLAN IS BASED ON PRELIMINARY
INFORMATION PROVIDED BY THE CLIENT. IT IS ONLY AS ACCURATE
AS THE INFORMATION PROVIDED. A THOROUGH SEARCH OF ZONING REQUIREMENTS INCLUDING, BUT NOT LIMITED TO SETBACKS, BUFFERS AND OTHER CITY PLANNING REQUIREMENTS IS NOT REFLECTED ON THIS DRAWING. AS SUCH, THE CLIENT IS STRONGLY ENCOURAGED TO CONTACT THE GOVERNING JURISDICTION TO REVIEW ADDITIONAL DEVELOPMENT REQUIREMENTS.

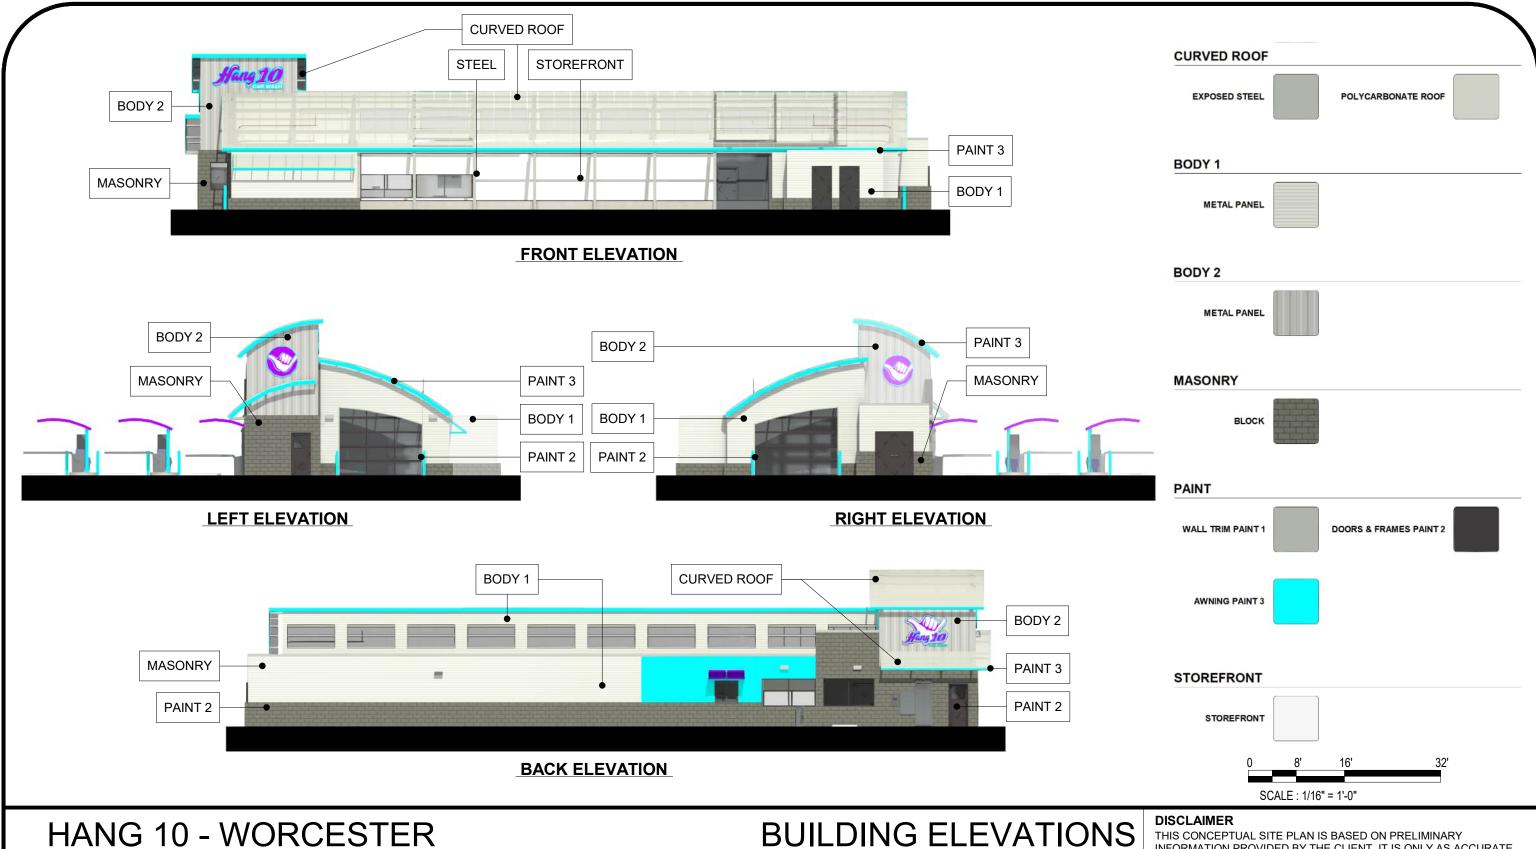

# HANG 10 - WORCESTER

PROJECT NO.: PDP23.CWB.002 1059 GRAFTON ST DATE: WORCESTER, MA

01/27/2023 DRAWN BY: MMK CHECKED BY: JTK





THIS CONCEPTUAL SITE PLAN IS BASED ON PRELIMINARY
INFORMATION PROVIDED BY THE CLIENT. IT IS ONLY AS ACCURATE AS THE INFORMATION PROVIDED. A THOROUGH SEARCH OF ZONING REQUIREMENTS INCLUDING, BUT NOT LIMITED TO SETBACKS, BUFFERS AND OTHER CITY PLANNING REQUIREMENTS IS NOT REFLECTED ON THIS DRAWING. AS SUCH, THE CLIENT IS STRONGLY ENCOURAGED TO CONTACT THE GOVERNING JURISDICTION TO REVIEW ADDITIONAL DEVELOPMENT REQUIREMENTS.









# HANG 10 - WORCESTER

1059 GRAFTON ST WORCESTER, MA

PDP23.CWB.002 PROJECT NO.: DATE: 01/27/2023 DRAWN BY: MMK CHECKED BY: JTK



# **PERSPECTIVES**



#### **DISCLAIMER**

THIS CONCEPTUAL SITE PLAN IS BASED ON PRELIMINARY
INFORMATION PROVIDED BY THE CLIENT. IT IS ONLY AS ACCURATE
AS THE INFORMATION PROVIDED. A THOROUGH SEARCH OF ZONING
REQUIREMENTS INCLUDING, BUT NOT LIMITED TO SETBACKS,
BUFFERS AND OTHER CITY PLANNING REQUIREMENTS IS NOT
REFLECTED ON THIS DRAWING. AS SUCH, THE CLIENT IS STRONGLY
ENCOURAGED TO CONTACT THE GOVERNING JURISDICTION TO REVIEW ADDITIONAL DEVELOPMENT REQUIREMENTS.